
SITE MAP Elton Ave Kodak Park Kodak Par BJ's Wholesale PROJECT LOCATION McCrackanville Trolley Blvd Albert St 00 ⁰² 1) Lvell Ave Lyell Ave State Highway 31 State Highw

MATERIAL SYMBOLS

| CONCRETE MASONRY UNITS (CMU) | STONE, GRAVEL, (FILL |
|---|--------------------------|
| CONCRETE | WOOD (FINISHED) |
| BRICK | WOOD (ROUGH) |
| CEMENT, SAND, GROUT, PLASTER, OR GYPSUM WALL BOARD | RIGID INSULATION |
| EARTH | STEEL |
| | |

REFERENCE SYMBOLS

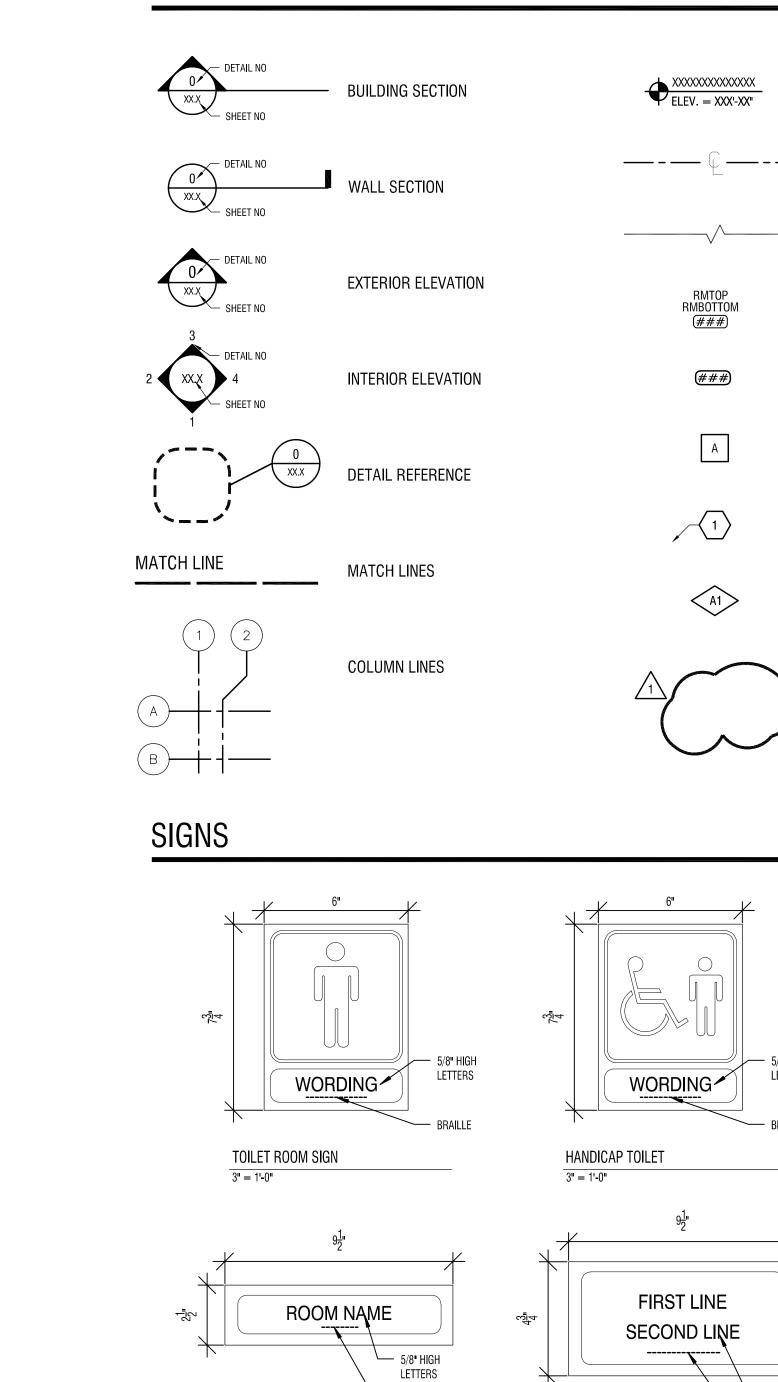

BRAILLE

ROOM NAME SIGN (2 LINE)

3" = 1'-0"

ROOM NAME SIGN 3" = 1'-0"



, OR POROUS

ASPHALT

BEDROCK

PAVEMENT SECTION

BATT. OR LOOSE INSULATION


ELEVATION $----- \bigcirc ---- \bigcirc ---- \bigcirc$ CENTER LINE CUT LINE ROOM IDENTIFIER DOOR IDENTIFIER WINDOW TYPE

KEYNOTE

WALL TYPE

REVISION SYMBOL AND CLOUD



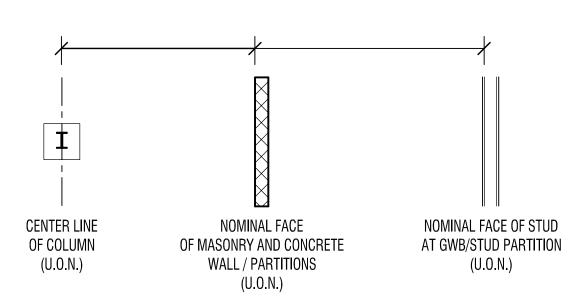


GENERAL NOTES

- CONSTRUCTION SHALL CONFORM TO THE "NEW YORK STATE UNIFORM FIRE PROTECTION AND BUILDING CODE", LATEST REVISION, THE NEW YORK STATE ENERGY CODE AND ANY OTHER CODES GOVERNED BY THE JURISDICTION IN WHICH THE PROJECT IS BEING CONSTRUCTED.
- CONSTRUCTION SHALL COMPLY WITH ALL LOCAL, STATE AND FEDERAL CODES AND REGULATIONS. ALL DRAWINGS ARE GRAPHIC REPRESENTATIONS OF APPROXIMATE LOCATIONS OF NEW MATERIALS. IT IS THE CONTRACTOR'S
- RESPONSIBILITY TO FIELD VERIFY ALL CONDITIONS PRIOR TO COMMENCEMENT OF WORK.
- CONTRACTORS ARE RESPONSIBLE FOR ALL MATERIALS, CONSTRUCTION METHODS AND CRAFTSMANSHIP.
- CONTRACTORS ARE TO VERIFY ALL EXISTING CONDITIONS, REQUIREMENTS, NOTES, CODES AND DIMENSIONS, PRIOR TO THE START OF CONSTRUCTION AND SHALL NOTIFY THE ARCHITECT IF CONDITIONS VARY FROM THOSE SHOWN ON THE DOCUMENTS.
- CONTRACTORS ARE TO PROVIDE ADEQUATE SUPPORT OF EXISTING FOUNDATION WALLS, LOAD BEARING WALLS AND PARTITIONS DURING DEMOLITION AND CONSTRUCTION
- THOROUGHLY COORDINATE WORK WITH OTHER TRADES AND DETERMINE THE EXACT ROUTE AND LOCATION OF UTILITIES, MATERIALS AND EQUIPMENT BEFORE FABRICATION AND INSTALLATION.

ABBREVIATIONS

| АСТ | ACOUSTICAL CEILING TILE | FIN | FINISH (ED |
|--------|----------------------------------|-------|------------------------------|
| AFF | ABOVE FINISH FLOOR | FL | FLOOR |
| AFG | ABOVE FINISH GRADE | FT | FOOT OR FEET |
| AHU | AIR HANDLING UNIT | | |
| ALUM | ALUMINUM | GALV | GALVANIZED |
| ALT | ALTERNATE | GC | GENERAL CONTRACTOR |
| APPROX | APPROXIMATE (LY) | GWB | GYPSUM WALL BOARD |
| AVG | AVERAGE | 0.112 | |
| | | HC | HEATING, VENTILATING AND AIR |
| BLDG | BUILDING | | CONDITIONING CONTRACTOR |
| BO | BOTTOM OF | HVAC | HEATING, VENTILATING AND AIR |
| BUR | BUILT UP ROOF | | CONDITIONING |
| | | HORIZ | HORIZONTAL |
| CFM | CUBIC FEET PER MINUTE | | |
| CFMF | COLD FORMED METAL FRAMING | D | INSIDE DIAMETER |
| CJ | CONTROL JOINT | IN | INCH |
| CLG | CEILING | INSUL | INSULATION |
| CLR | CLEAR | INT | INTERIOR |
| CIP | CAST IN PLACE | | |
| CMU | CONCRETE MASONRY UNIT | LOC | LOCATION |
| COL | COLUMN | | |
| CONC | CONCRETE | MAX | MAXIMUM |
| CONT | CONTINUOUS | MFG | MANUFACTURER |
| CU | CUBIC | MECH | MECHANICAL |
| | | MIN | MINIMUM |
| DEMO | DEMOLISH | MISC | MISCELLANEOUS |
| DIA | DIAMETER | MO | MASONRY OPENING |
| DWG | DRAWING | MTD | MOUNTED |
| | | MTG | MOUNTING |
| EC | ELECTRICAL CONTRACTOR | | |
| ELEV | ELEVATION | NA | NOT APPLICABLE |
| EPDM | ETHYLENE PROPYLENE DIENE MONOMER | NIC | NOT IN CONTRACT |
| ETR | EXISTING TO REMAIN | NTS | NOT TO SCALE |
| EQ | EQUAL | | |
| EXIST | EXISTING | 00 | ON CENTER |
| EXT | EXTERIOR | OD | OUTSIDE DIAMETER |
| | | OH | OVERHEAD |
| | | OPP | OPPOSITE HAND |
| | | | |

SIGN MOUNTING HEIGHTS

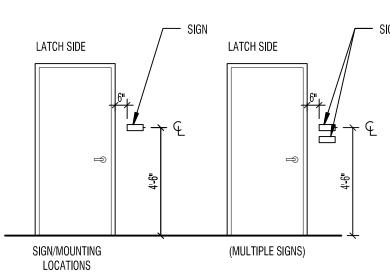

SIGN NOTES:

- 1. SIGN SIZES ARE APPROXIMATE AND MAY VARY BY MANUF. 2. SIGN COLOR TO BE SELECTED BY ARCHITECT
- 3. CENTER LINE OF SIGNAGE TO BE 54" A.F.F.

DIRECTIONAL SIGN (2 LINE) 3" = 1'-0"

— 5/8" HIGH — 5/8" HIGH WORDING LETTERS LETTERS WORDING - BRAILLE - BRAILLE HANDICAP TOILET 3" = 1'-0" TOILET ROOM SIGN HANDICAP SYMBOL 3" = 1'-0" 3" = 1'-0" FIRST LINE **USE STAIR DURING** ∞ 3 FIRE EMERGENCY പ്പ 2" HIGH LETTERS 5/8" HIGH LETTERS └── 5/8" HIGH BRAILLE LETTERS - BRAILLE — BRAILLE FIRE SIGN 3" = 1'-0" DIRECTIONAL SIGN 3" = 1'-0"

FLOOR SIGN 3" = 1'-0"

| | LIST OF DRAWINGS: |
|---|--|
| NOMINAL FACE OF STUD AT GWB/STUD PARTITION (U.O.N.) | GENERAL G000 COVER SHEET G001 PROJECT INFORMATION & DRAWING LIST G101 FIRST FLOOR CODE PLAN G102 SECOND FLOOR CODE PLAN G103 THIRD FLOOR CODE PLAN G103 THIRD FLOOR CODE PLAN G104 GENERAL NOTES & ABBREVIATIONS V001 EXISTING CONDITIONS PLAN L001 LOGISTICS PLAN C002 DEMOLITION PLAN C003 DEMOLITION PLAN C003 DEMOLITION PLAN C101 SITE MATERIALS, LAYOUT & PLANTING PLAN C102 SITE MATERIALS, LAYOUT 4 PLANTING PLAN C103 SITE MATERIALS, LAYOUT 4 PLANTING PLAN |
| WHEN EXISTING CONSTRUCTION IS REMOVED, DISTURBED, DAMAGED, REPLACED OR RENOVATED IN ANY WAY, CONTRACTORS SHALL PROVIDE PATCHING, PAINTING AND MATERIALS OF SAME TYPE AND QUALITY AS TO MATCH ADJACENT EXISTING SURFACES, UNLESS OTHERWISE NOTED. CONTRACTORS PROVIDE ALL BLOCKING, FURRING AND SHIMMING FOR INSTALLATION AND COMPLETION OF WORK. ALL NEW WORK SHALL BE PLUMB, LEVEL AND SQUARE. SCRIBE AND MAKE FIT ALL NEW TO EXISTING. CONTRACTORS VERIFY ALL DIMENSIONS BEFORE ORDERING MATERIAL OR DOING WORK. NO EXTRA COMPENSATION OR CHARGES WILL BE ACCEPTED DUE TO DIFFERENCES BETWEEN THE ACTUAL MEASUREMENTS AND MEASUREMENTS INDICATED ON THE DRAWINGS. ITEMS NOTED AS 'BY OWNER" ARE TO BE FURNISHED AND INSTALLED BY THE OWNER OR THE OWNER'S VENDOR. OWNER PROVIDED EQUIPMENT IS INDICATED FOR REFERENCE ONLY. VERIFY DIMENSIONS AND CLEARANCE REQUIREMENTS WITH ACTUAL EQUIPMENT | C201 GRADING PLAN C202 GRADING PLAN C203 GRADING PLAN C301 UTILITY PLAN C302 UTILITY PLAN C601 DETAILS C602 DETAILS C603 DETAILS C604 DETAILS C605 DETAILS C605 DETAILS C606 AGENCY DETAILS C607 AGENCY DETAILS STRUCTURAL S001 GENERAL STRUCTURAL NOTES & DESIGN CRITERIA S101 EAST ELEVATION RETAINING WALL REPAIRS S102 EAST ELEVATION RETAINING WALL REPAIRS |
| PROVIDED. 14. SECURITY, WEATHERPROOPING, DUST CONTROL AND SAFETY SHALL BE THE FULL RESPONSIBILITY OF THE CONTRACTOR. IMISH (ED FLOOR PC PLAM PLAM PLASTIC LAMINATE POT OR FEET PT PRESSURE TREATED GALVANIZED QTY GALVANIZED QTY GENERAL CONTRACTOR QTY GYPSUM WALL BOARD RD HEATING, VENTILATING AND AIR REF REFERENCE CONDITIONING CONTRACTOR CONDITIONING CONTRACTOR RO ROUGH OPENING RTU HORTONING RTU HORTONING RTU HORTONING RTU NSIDE DIAMETER SPECIFICATION NICH SQ IN SQUARE FOOT SO IN NICH SQ IN SQUARE FOOT STD STD STANDARD LOCATION TBD MASONRY OPENING UN MINIMUM TYP MINIMUM VIF VERIFY OPTING VIF VOL VOLUME NOT TO SCALE W/O NOT TO SCALE W/O NOT TO SCALE W/O | |
| <section-header><section-header><section-header></section-header></section-header></section-header> | A614 WINDOW DETAILS MECHANICAL M000 MECHANICAL NOTES, LEGENDS, AND DETAILS M001 BASEMENT DEMOLITION PLAN - AREA B, D, & E M002 BASEMENT DEMOLITION PLAN - AREA G & H M003 FIRST FLOOR DEMOLITION PLAN M004 SECOND FLOOR DEMOLITION PLAN M005 THIRD FLOOR DEMOLITION PLAN M006 PENTHOUSE 1 AND 2 DEMOLITION PLAN M007 ENLARGED DEMOLITION PLAN M007 ENLARGED DEMOLITION PLAN M008 PENTHOUSE 1 AND 2 DEMOLITION PLAN M009 PENTHOUSE 1 AND 2 DEMOLITION PLAN M009 PENTHOUSE 1 AND 2 DEMOLITION PLAN M009 PENTHOUSE 1 AND 2 DEMOLITION PLAN M010 BASEMENT NEW WORK PLAN - AREA B, D, & E M101 BASEMENT NEW WORK PLAN - AREA G & H M103 FIRST FLOOR NEW WORK PLAN M104 SECOND FLOOR NEW WORK PLAN M105 THIRD FLOOR NEW WORK PLAN M106 PENTHOUSE 1 AND 2 NEW WORK PLAN M106 PENTHOUSE 1 AND 2 NEW WORK PLAN M107 CHILLED WATER PLANT SCHEMATIC - DEMOLITION M501 CHILLED WATER PLANT SCHEMATIC - DEMOLITION M502 CHILLED WATER PLANT SCHEMATIC - NEW WORK M601 MECHANICAL DETAILS M602 MECHANICAL DETAILS M602 CONTROLS SCHEMATICS - CHILLER PLANT M902 CONTROLS SCHEMATICS - CHILLER PLANT M903 CONTROLS SCHEMATICS - CHILLER PLANT M904 DUMBING NOTES, LEGENDS, AND SCHEDULES P405 PLUMBING NOTES, LEGENDS, AND SCHEDULES P405 PLUMBING NOTES, LEGENDS, AND SCHEDULES P404 ENLARGED DEMOLITION PLANS P402 ENLARGED DEMOLITION PLANS P402 ENLARGED DEMOLITION PLANS P404 ENLARGED DEMOLITION PLANS P405 ENLARGED DEMOLITION PLANS P404 ENLARGED DEMOLITION PLANS P405 ENLARGED DEMOLITION PLANS P40 |
| RST LINE SIGN DIRECTIONAL SIGN (2 LINE) | E000 ELECTRICAL NOTES, SYMBOLS, & ABBREVIATIONS E001 ELECTRICAL SITE PLAN DEMO E002 ELECTRICAL SITE PLAN E012 ROOF ELECTRICAL DEMOLITION PLAN - LIGHTNING PROTECTION AREA D, E, F, G, & H E013 ROOF SPECIAL SYSTEMS PLAN - AREAS D, E, F, G, & H E101 MECHANICAL ROOM ELECTRICAL DEMOLITION PLAN E102 BASEMENT ELECTRICAL DEMOLITION PLAN - AREAS G & H E103 ROOF AND PENTHOUSE 1 ELECTRICAL DEMOLITION PLAN E104 PENTHOUSE 3 AND 5 ELECTRICAL DEMOLITION PLAN E201 MECHANICAL ROOM ELECTRICAL DEMOLITION PLAN E202 FIRST FLOOR ELECTRICAL SPECIAL SYSTEMS PLAN - AREAS A, B, C, D, & E E203 FIRST FLOOR ELECTRICAL SPECIAL SYSTEMS PLAN - AREAS A, B, C, D, & E E204 BASEMENT ELECTRICAL PLAN - AREA G/H E205 ROOF AND PENTHOUSE 1 ELECTRICAL PLAN E302B SECOND FLOOR LIGHTING PLAN |

E401 ENLARGED ELECTRICAL PLANS 1ST AND 2ND FLOOR



DRAWING NUMBER:

DRAWING NAME:

PROJECT INFORMATION

| REVISION | 6 | | | | |
|-----------|-----------------|----------------|--|--|--|
| NO: | DATE: | DESCRIPTION: | | | |
| 1 | 6.28.19 | BID ADDENDUM 1 | | | |
| | | | | | |
| | | | | | |
| | | | | | |
| PROJECT N | PROJECT NUMBER: | | | | |
| | | 2170218 | | | |
| DRAWN BY | | | | | |
| | CRG | | | | |
| REVIEWED | REVIEWED BY: | | | | |
| MES | | | | | |
| ISSUED FO | ISSUED FOR: | | | | |
| | BID DOCUMENTS | | | | |
| DATE: | | | | | |
| | JUNE 26, 2019 | | | | |

SED NO. 26-16-00-01-0-111-032 DWT NO. 26-16-00-01-7-999-020

655 COLFAX STREET ROCHESTER, NY 14606

EDISON TECHNICAL SCHOOL

1776 N. CLINTON AVE ROCHESTER, NY 14621

ROCHESTER SCHOOLS MODERNIZATION PROGRAM

© 2019 LaBella Associates

It is a violation of New York Education Law Article 145 Sec.7209, for any person, unless acting under the direction of a licensed architect, professional engineer, or land surveyor, to alter an item in any way. If an item bearing the seal of an architect, engineer, or land surveyor is altered; the altering architect, engineer, or land surveyor shall affix to the item their seal and notation "altered by" followed by their signature and date of such alteration, and a specific description of the alteration.

ear 555 Penbrooke Drive • Penfield, NY 14526 main: 585.388.2060 • fax: 585.388.2070

Razak Associates ARCHITECTURE ENGINEERING LAND SURVEYING INTERIORS PLANNING LANDSCAPE 2050 FAIRPORT-NINE MILE POINT ROAD, SUITE 410 PENTILLD, NY 14520 PHONE: 585.377.3550 + FAX: 585.377.3559

Powered by partnership. 300 State Street, Suite 201 Rochester, NY 14614 585-454-6110 labellapc.com





SUPPLEMENT OF NEW YORK STATE. IT IS THE CONTRACTOR'S RESPONSIBILITY TO BECOME FAMILIAR WITH THE STATEMENT OF SPECIAL INSPECTIONS, SUBMIT ALL REQUIRED DOCUMENTATION, AND ALLOW THE OWNER'S TESTING AND INSPECTION AGENCY ACCESS TO PERFORM ALL REQUIRED TESTS AND INSPECTIONS. AS PART OF THIS PROGRAM, THE CONTRACTOR SHALL ALSO SUBMIT A COPY OF THEIR QUALITY CONTROL PROCEDURES AND CONTACT INFORMATION FOR ALL PERSONNEL RESPONSIBLE FOR EXECUTION OF THE SAME.

STRUCTURAL DESIGN LOADS AND PARAMETERS IBC SECTION 1603: CONSTRUCTION DOCUMENTS

S1 STRUCTURAL STEEL SHALL BE NEW STEEL CONFORMING TO THE FOLLOWING REQUIREMENTS:

ASTM A992

ASTM A36 ASTM A36 ASTM A36

S2 HIGH STRENGTH BOLTS, NUTS AND WASHERS SHALL CONFORM TO THE REQUIREMENTS OF ASTM A325 OR A490 (3/4"

S5 BEAM-TO-BEAM AND BEAM-TO-COLUMN CONNECTIONS SHALL BE SIMPLE SHEAR CONNECTIONS CAPABLE OF END ROTATIONS PER AISC "SPECIFICATION FOR THE DESIGN, FABRICATION AND ERECTION OF STRUCTURAL STEEL BUILDINGS" SECTION J1.2 - SIMPLE CONNECTIONS UNLESS NOTED OTHERWISE. CONNECTIONS SHALL UTILIZE HIGH STRENGTH BOLTS IN "SNUG-TIGHT" BEARING CONNECTIONS UNLESS OTHERWISE NOTED, WITH THE THREADS EXCLUDED FROM THE SHEAR PLANE. DESIGN ALL CONNECTIONS FOR THE FOLLOWING MINIMUM REACTIONS, UNLESS NOTED

> W18 - 60 KIPS W16 - 45 KIPS W14 - 45 KIPS W8 - 12 KIPS

A. W-SHAPES

B. CHANNELS

C. ANGLES

OTHERWISE:

W27 - 95 KIPS

W24 - 85 KIPS

W21 - 75 KIPS

MINIMUM DIAMETER).

D. MISC. SHAPES, PLATES, & BARS

S6 THE MINIMUM SIZE OF FILLET WELDS SHALL BE AS REQUIRED BY THE AISC SPECIFICATION SECTION J2 - WELDS, BUT SHALL NOT BE LESS THAN 1/4" UNLESS SPECIFICALLY NOTED ON THE DRAWINGS.

W12 - 30 KIPS

W10 - 15 KIPS

S7 CONNECTION TO THE EXISTING STRUCTURE SHALL BE AS DETAILED ON THE DRAWINGS OR AS APPROVED BY THE ARCHITECT. THE CONTRACTOR SHALL MAKE ALL NECESSARY FIELD MEASUREMENTS OF, COORDINATE DETAILS WITH AND FIELD VERIFY ALL EXISTING CONDITIONS PRIOR TO THE PREPARATION OF SHOP DRAWINGS.

S8 TEMPORARY ERECTION BRACING SHALL BE PROVIDED AS REQUIRED TO HOLD STRUCTURAL STEEL SECURELY IN POSITION. IT SHALL NOT BE REMOVED UNTIL PERMANENT BRACING HAS BEEN INSTALLED. THE BUILDING SHALL BE TRUE AND PLUMB BEFORE CONNECTIONS MAY BE FINALLY BOLTED OR WELDED.

S9 NOTE SPECIFICATION REQUIREMENTS FOR SPECIAL INSPECTION OF STRUCTURAL STEEL WORK. S10 WHERE NO CAMBER IS INDICATED, BEAMS SHALL BE FABRICATED WITH NATURAL CAMBER UPWARD. GOVERNING BUILDING CODE **BUILDING OCCUPANCY CATEGORY** DESIGN SOIL BEARING CAPACITY ROOF LIVE LOAD ROOF CONSTRUCTION LOAD SNOW LOAD

SNOW LOAD IMPORTANCE FACTOR, I GROUND SNOW LOAD, Pa

FLAT ROOF SNOW LOAD, P_f

SNOW EXPOSURE FACTOR, Ce

THERMAL FACTOR, Ct SNOW DRIFTING - MAXIMUM LOADS (PER ASCE 7-10)

WIND LOAD - MAIN WIND FORCE RESISTING SYSTEM

BASIC WIND SPEED, V WIND EXPOSURE

VELOCITY PRESSURE EXPOSURE COEFFICIENT, Kz

TOPOGRAPHIC FACTOR, Kzt WIND DIRECTIONALITY FACTOR, Kd

WIND LOAD - COMPONENTS AND CLADDING

REFER TO COMPONENTS AND CLADDING TABLE BELOW. FOR EFFECTIVE WIND AREAS BETWEEN THOSE SPECIFICALLY LISTED, LOADS SHALL BE INTERPOLATED.

<u>NOTES:</u>

1. POSITIVE AND NEGATIVE NUMBERS INDICATE FORCES/PRESSURES ACTING TOWARD AND AWAY FROM THE SURFACES RESP 2. END ZONES EXTEND FROM BUILDING CORNERS A DISTANCE EQUAL TO 10% OF THE LEAST HORIZONTAL DIMENSION BUT NO FEET.

SEISMIC LOAD

SEISMIC IMPORTANCE FACTOR, IE

SITE SOIL CLASSIFICATION

MAPPED SHORT PERIOD SPECTRAL ACCELERATION, S_S MAPPED ONE SECOND PERIOD SPECTRAL ACCELERATION, S1

SHORT PERIOD SPECTRAL DESIGN ACCELERATION, SDS

ONE SECOND PERIOD SPECTRAL DESIGN ACCELERATION, S_{D1}

SEISMIC DESIGN CATEGORY ARCHITECTURAL, MECHANICAL, ELECTRICAL, AND PLUMBING COMPONENTS REQUIRING SEISMIC BRACING

ARCHITECTURAL COMPONENTS

IMPORTANCE FACTOR, lp = 1.0

IMPORTANCE FACTOR, lp = 1.5 M / E / P COMPONENTS

IMPORTANCE FACTOR, lp = 1.0

IMPORTANCE FACTOR, lp = 1.5

| MA | DETAIL | | | | |
|--|--------------------------------------|----------------------------------|--------|--|--|
| UP TO 4'-0 | 4'-1 TO 6'-0 | 4'-1 TO 6'-0 6'-1 TO 8'-0 | | | |
| L 3 1/2 x 3 1/2 x 1/4 OR ST3 x 6.25 | | | _ OR ⊥ | | |
| 2 L'S 3 1/2 x 2 1/2 x5/16 | WT 7 x 11 | WT 7 x 11 | | | |
| 2 L'S 3 1/2 x 3 1/2 x 1/4 | 2 L'S 4 x 3 1/2 x 5/16 | 2 L'S 5 x 3 1/2 x 5/16 | | | |
| L 5 x 3 1/2 x 1/4 L 4 x 4 x 1/4 | L 5 x 3 1/2 x 5/16 L 4 x 4 x 5/16 | L 5 x 5 x 5/16 L 4 x 4 x 5/16 | | | |
| 3 L'S 3 1/2 x 3 1/2 x 5/16 | 3 L'S 4 x 3 1/2 x 5/16 | 3 L'S 6 x 3 1/2 x 5/16 | | | |
| 4 L'S 3 1/2 x 3 1/2 x 5/16 | 4 L'S 4 x 3 1/2 x 5/16 | 4 L'S 6 x 3 1/2 x 5/16 | | | |
| 4" 6" 8" ^{ALL ANGLES} | | | | | |
| NOTE: 1. HOT-DIP GALVANIZE ALL PIECES OF ALL LINTELS IN EXTERIOR WALLS. 2. LINTELS FOR OPENINGS LARGER THAN 8" X 8" FOR HVAC, ELECTRICAL AND PLUMBING SHAL BE PROVIDED AND INSTALLED BY THE GENERAL CONTRACTOR. COORDINATE QUANTITY, LOCATION AND SIZES WITH ALL TRADES. | | | | | |

COORDINATE QUANTITY, LOCATION AND SIZES WITH ALL TRADES. 3. LINTELS ON EXTERIOR WALLS SHALL HAVE A MINIMUM THICKNESS OF 5/16".

WALL

HICKNES

4"

6"


8"

10"

12"

16"


4. FOR OPENINGS ON MASONRY WALLS NOT MARKED ON PLAN, USE APPROPRIATE SIZE FROM THIS TABLE OR CONTACT ARCHITECT / ENGINEER.

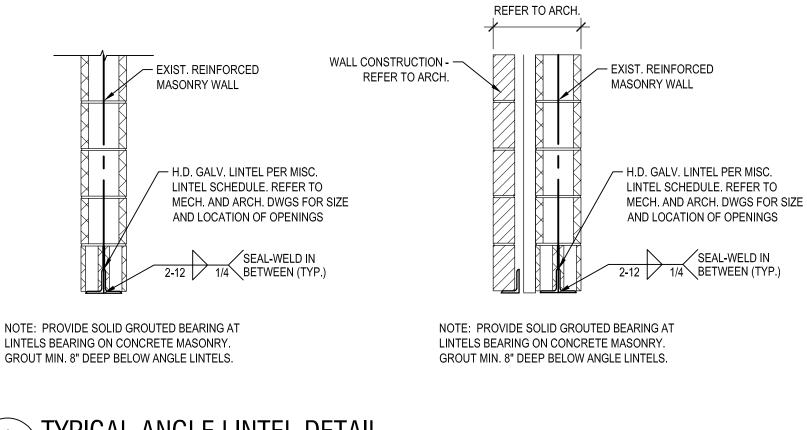

S001 N.T.S.

| GN LOADS AND PARAME | TERS | ABB | REVIATIONS |
|--|----------|----------------|-----------------------------|
| | | AFF | ABOVE FINISH FLOOR |
| 2015 INTERNATIONAL BUILDING CODE WITH 2017 NEW YORK STATE SUP | PLEMENT | ARCH. | ARCHITECTURAL |
| | | BRG. | BEARING |
| 8000 PSF (ROCK - BASED ON ORIGINAL CONSTRUCTION DF | RAWINGS) | B/ | BOTTOM OF |
| | | CLR. C.J. | CLEAR CONSTRUCTION JOINT |
| | 20 PSF | CONC. | CONCRETE |
| | | CONT. | CONTINUOUS |
| | 1.10 | CMU | CONCRETE MASONRY UNIT |
| | 40 PSF | DIA. | DIAMETER |
| | 30.5 PSF | DN | DOWN |
| | 1.00 | DWG. | DRAWING |
| | 1.00 | ELEC. | ELECTRICAL |
| | | ELEV. EQ. | ELEVATION EQUAL |
| | | EQ. EA. | EQUAL |
| | 120 MPH | E.W. | EACH WAY |
| | C | E.J. | EXPANSION JOINT |
| | 1.08 | E.J.D. | EXPANSION JOINT W/DOWEL |
| | 1.00 | ELEV. | ELEVATION |
| | 0.85 | EXIST. | EXISTING |
| | | EXP. | EXPANSION |
| OR EFFECTIVE WIND AREAS BETWEEN THOSE SPECIFICALLY LISTED, DESIG | N WIND | | FINISH FLOOR |
| | | FT. | FOOT FOUNDATION |
| | | FND. GA | GAUGE |
| PRESSURES ACTING TOWARD AND AWAY FROM THE SURFACES RESPECTIV | ELY. | GALV. | GAUVANIZED |
| ANCE EQUAL TO 10% OF THE LEAST HORIZONTAL DIMENSION BUT NOT LESS | THAN 3 | HORIZ. | HORIZONTAL |
| | | H.D. | HOT DIP |
| | | I.D. | INSIDE DIAMETER |
| | 1.25 | LF | LINEAR FEET |
| D (A | SSUMED) | LLV | LONG LEG VERTICAL |
| | 0.165 g | M.E. | MATCH EXISTING MAXIMUM |
| S ₁ | 0.060 g | MAX. MECH. | MECHANICAL |
| | 0.176 g | MIN. | MINIMUM |
| S _{D1} | 0.096 g | NOM. | NOMINAL |
| | В | N.T.S. | NOT TO SCALE |
| G COMPONENTS REQUIRING SEISMIC BRACING | | O.D. | OUTSIDE DIAMETER |
| | | 0.C. | ON CENTER |
| | EXEMPT | R | RADIUS |
| | EXEMPT | REF. REINF. | REFERENCE REINFORCEMENT |
| | | S.J. | SAWCUT JOINT |
| | EXEMPT | SCH. | SCHEDULE |
| | EXEMPT | SIM. | SIMILAR |
| | | SF | SQUARE FEET |
| | | ST. | STAINLESS |
| | | STD. | STANDARD |
| | | STL. | STEEL |
| | | THK. | |
| | | T.J. T/ | TOOLED JOINT TOP OF |
| | | TYP. | TYPICAL |
| | | VERT | VERTICAL |
| | | V.I.F. | VERIFY IN FIELD |
| | | WT | WEIGHT |
| | | WWF | WELDED WIRE FABRIC |
| | | W/ | WITH |
| | | WF | WIDE ELANGE |

TYPICAL ANGLE LINTEL DETAIL

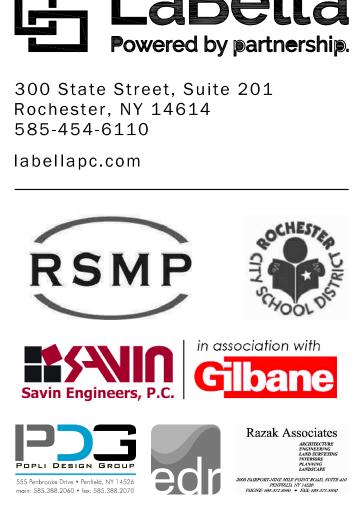

| $\[\]$ | \top | |
|--|---|--|
| | | |
| | | |
| | \perp | |
| Article 145 acting under professiona an item in ar an archit altered; the surveyor s notation "al and date | ation of New York Educ 5 Sec.7209, for any per the direction of a licen I engineer, or land surv by way. If an item beari ect, engineer, or land s altering architect, engi shall affix to the item the tered by" followed by th of such alteration, and escription of the alterati | son, unless sed architect, reyor, to alter ng the seal of surveyor is neer, or land eir seal and heir signature a specific |
| | © 2019 LaBella Associates | |
| ROCI | HESTER SCH | OOLS |
| | NIZATION PF | |
| | 1776 N. CLINTON AV ROCHESTER, NY 146 | |

WIDE FLANGE

WF

RUCHESTER, NY 14621

EDISON TECHNICAL SCHOOL 655 COLFAX STREET

ROCHESTER, NY 14606

SED NO. 26-16-00-01-0-111-032

DWT NO. 26-16-00-01-7-999-020

2170218

ERL

.IMF

BID DOCUMENTS

JUNE 26, 2019

GENERAL STRUCTURAL NOTES

& DESIGN CRITERIA

REVISIONS

PROJECT NUMBER:

DRAWN BY:

REVIEWED BY:

ISSUED FOR:

DRAWING NAME:


DRAWING NUMBER:

DATE:


NO: DATE: DESCRIPTION:

1 6.28.19 BID ADDENDUM 1

S001

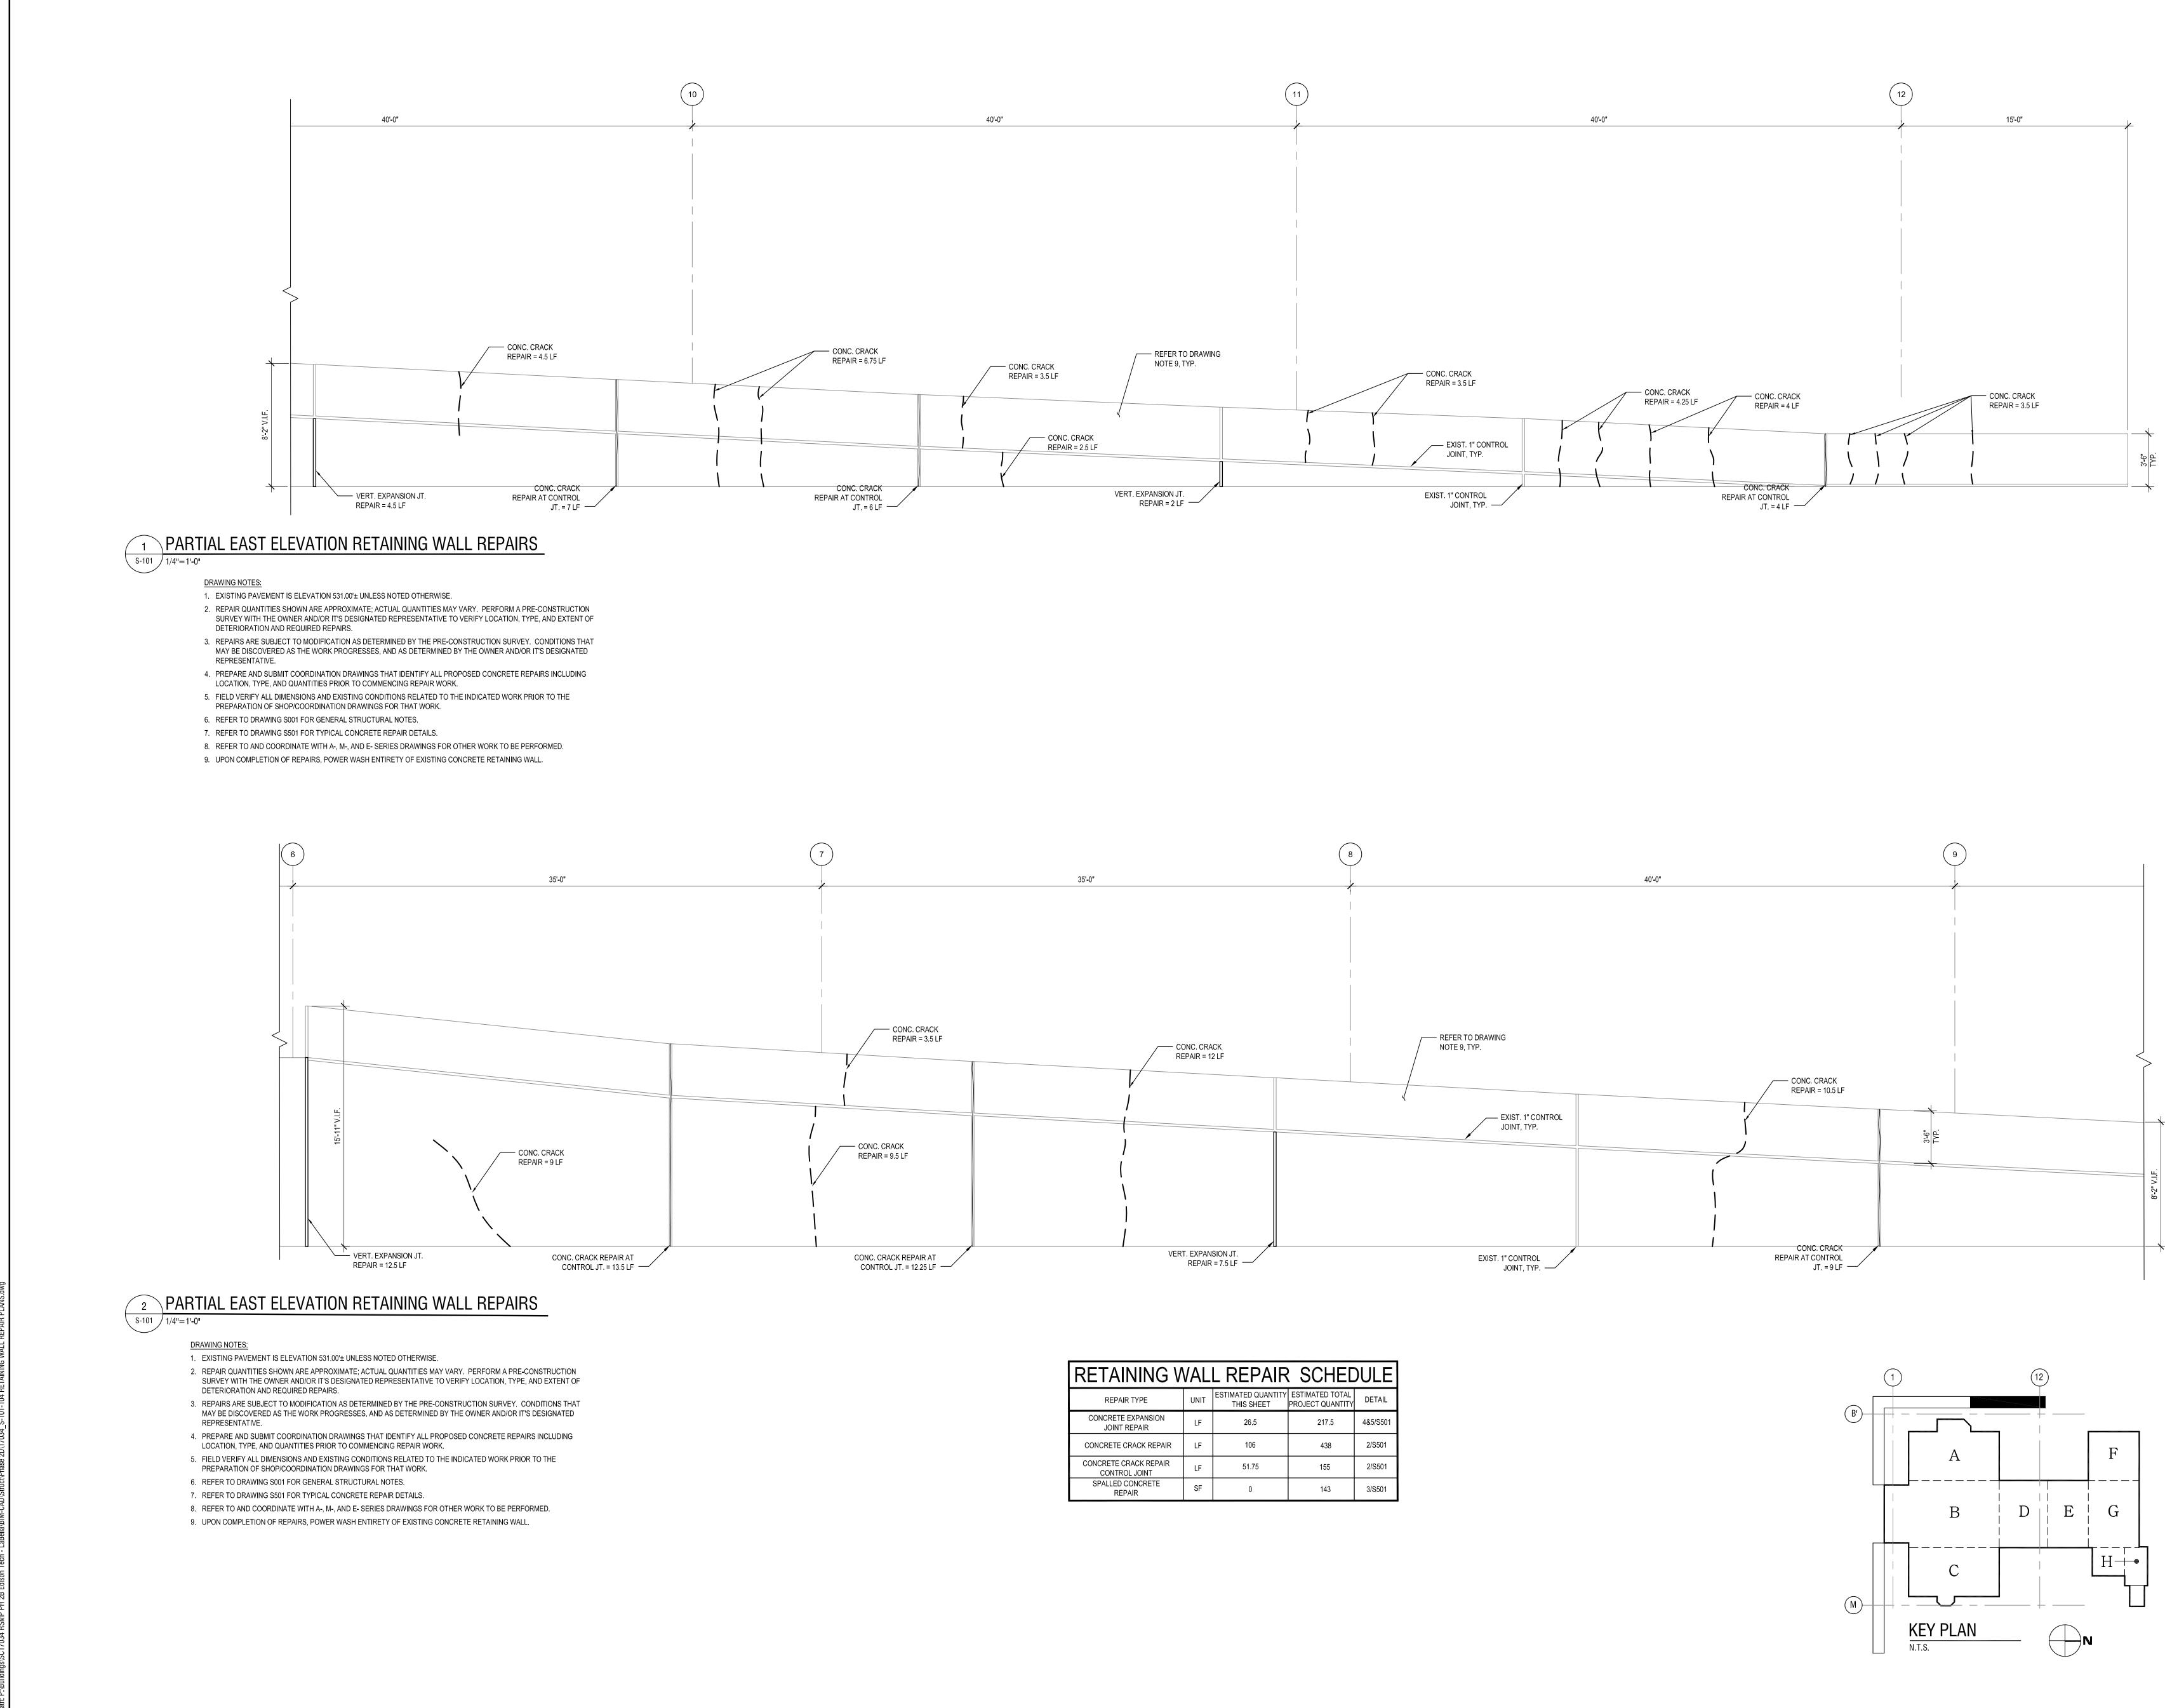

| RETAINING WALL REPAIR SCHEDULE | | | | |
|--|------|----------------------------------|-------------------------------------|----------|
| REPAIR TYPE | UNIT | ESTIMATED QUANTITY THIS SHEET | ESTIMATED TOTAL PROJECT QUANTITY | DETAIL |
| CONCRETE EXPANSION JOINT REPAIR | LF | 26.5 | 217.5 | 4&5/S501 |
| CONCRETE CRACK REPAIR | LF | 106 | 438 | 2/S501 |
| CONCRETE CRACK REPAIR CONTROL JOINT | LF | 51.75 | 155 | 2/S501 |
| SPALLED CONCRETE REPAIR | SF | 0 | 143 | 3/S501 |

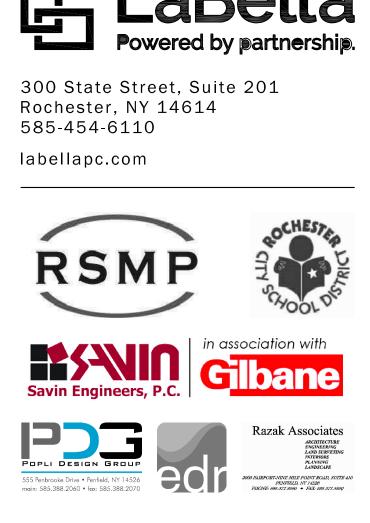

| | | I | | 1 |
|--|--|--|---|---|
| | | | | |
| | | | | |
| Article acting ur professi an item i an ar altered; survey notation | violation of N 145 Sec.720 onder the direct onal engineer n any way. If chitect, engine the altering a vor shall affix "altered by" late of such a description | 9, for an tion of a r, or lanc an item neer, or la architect, to the ite followed alteration | y person, un licensed arc l surveyor, to bearing the s and surveyor engineer, or em their seal by their sign , and a spec | less hitect, alter seal of r is r land and ature |
| | © 2019 L | .aBella Assoc | ciates | |
| | | | | |
| | CHEST | | | |
| MODE | RNIZA | TION | PROG | RAM |
| | 1776 N. | | | |
| | ROCHEST | ER, NY | 14021 | |
| EDI | SON TEC | HNICA | L SCHOO | L |
| | 655 COL ROCHEST | | | |
| SE | D NO 26-16 | 5-00-01 | _0_111_032 |) |

 \top


SED NO. 26-16-00-01-0-111-032 DWT NO. 26-16-00-01-7-999-020

| REVISION | REVISIONS | | | | |
|------------------|------------------------|--------------|--|--|--|
| NO: | DATE: | DESCRIPTION: | | | |
| 1 | 6.28.19 BID ADDENDUM 1 | | | | |
| | | | | | |
| | | | | | |
| | | | | | |
| PROJECT NUMBER: | | | | | |
| | | 2170218 | | | |
| DRAWN BY: ERL | | | | | |
| REVIEWED BY: JMF | | | | | |
| | | | | | |
| ISSUED FOR: | | | | | |
| | BID DOCUMENTS | | | | |
| DATE: | | | | | |
| | JUNE 26, 2019 | | | | |


DRAWING NAME:

EAST ELEVATION RETAINING WALL REPAIRS



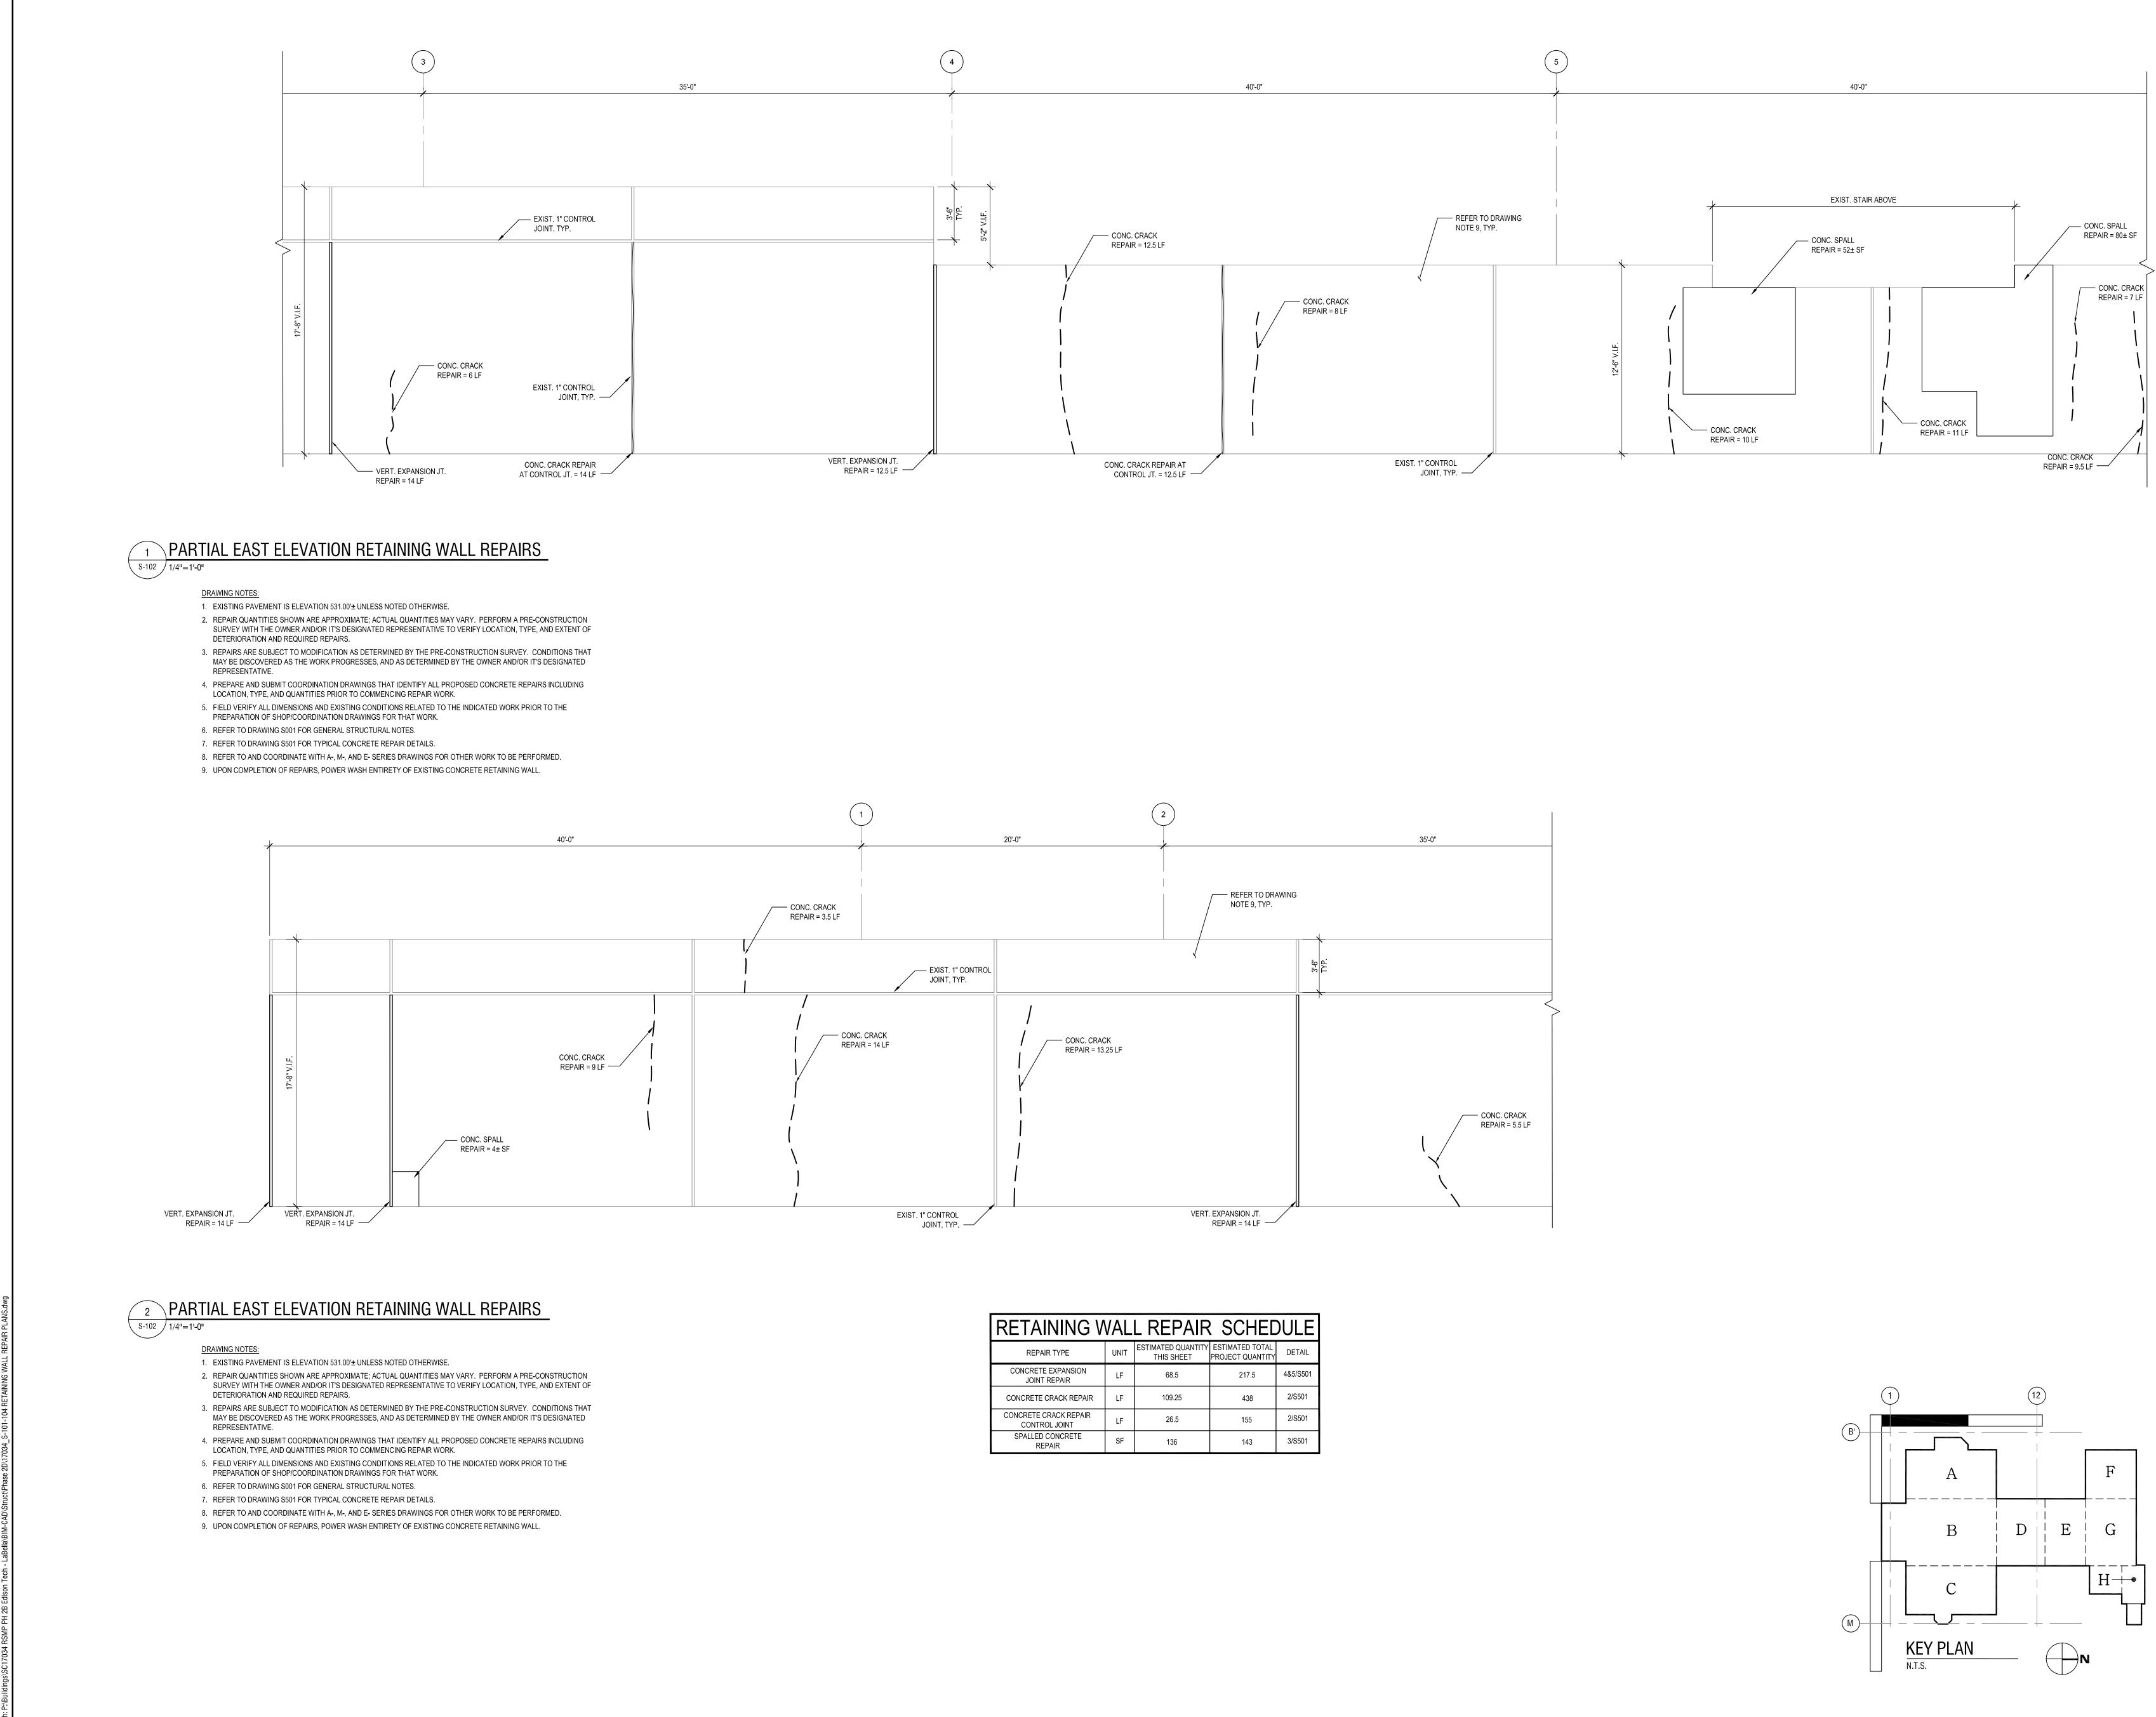

| RETAINING WALL REPAIR SCHEDULE | | | | |
|--|------|----------------------------------|-------------------------------------|----------|
| REPAIR TYPE | UNIT | ESTIMATED QUANTITY THIS SHEET | ESTIMATED TOTAL PROJECT QUANTITY | DETAIL |
| CONCRETE EXPANSION JOINT REPAIR | LF | 68.5 | 217.5 | 4&5/S501 |
| CONCRETE CRACK REPAIR | LF | 109.25 | 438 | 2/S501 |
| CONCRETE CRACK REPAIR CONTROL JOINT | LF | 26.5 | 155 | 2/S501 |
| SPALLED CONCRETE REPAIR | SF | 136 | 143 | 3/S501 |

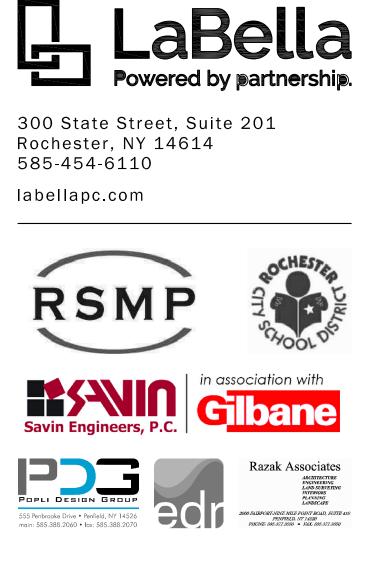

| | \top | |
|---|--|---|
| | | |
| | \perp | |
| Article 1 acting und professior an item in an arch altered; th surveyor notation " and da | iolation of New York E45 Sec.7209, for any p ler the direction of a lic nal engineer, or land su any way. If an item be nitect, engineer, or land ne altering architect, er r shall affix to the item altered by" followed by te of such alteration, a description of the alter | berson, unless ensed architect, urveyor, to alter aring the seal of d surveyor is ngineer, or land their seal and their signature nd a specific |
| | © 2019 LaBella Associate | |

MODERNIZATION PROGRAM 1776 N. CLINTON AVE ROCHESTER, NY 14621

EDISON TECHNICAL SCHOOL 655 COLFAX STREET ROCHESTER, NY 14606


SED NO. 26-16-00-01-0-111-032 DWT NO. 26-16-00-01-7-999-020

| REVISIONS | | | | | | | | | | | |
|-----------|---------------|----------------|--|--|--|--|--|--|--|--|--|
| NO: | DATE: | DESCRIPTION: | | | | | | | | | |
| 1 | 6.28.19 | BID ADDENDUM 1 | | | | | | | | | |
| | | | | | | | | | | | |
| | | | | | | | | | | | |
| | | | | | | | | | | | |
| PROJECT N | NUMBER: | | | | | | | | | | |
| | | 2170218 | | | | | | | | | |
| DRAWN BY | /. | ERL | | | | | | | | | |
| REVIEWED | BY: | JMF | | | | | | | | | |
| | | | | | | | | | | | |
| ISSUED FO | | | | | | | | | | | |
| | BID DOCUMENTS | | | | | | | | | | |
| DATE: | | | | | | | | | | | |
| | JUNE 26, 2019 | | | | | | | | | | |

DRAWING NAME:

EAST ELEVATION RETAINING WALL REPAIRS



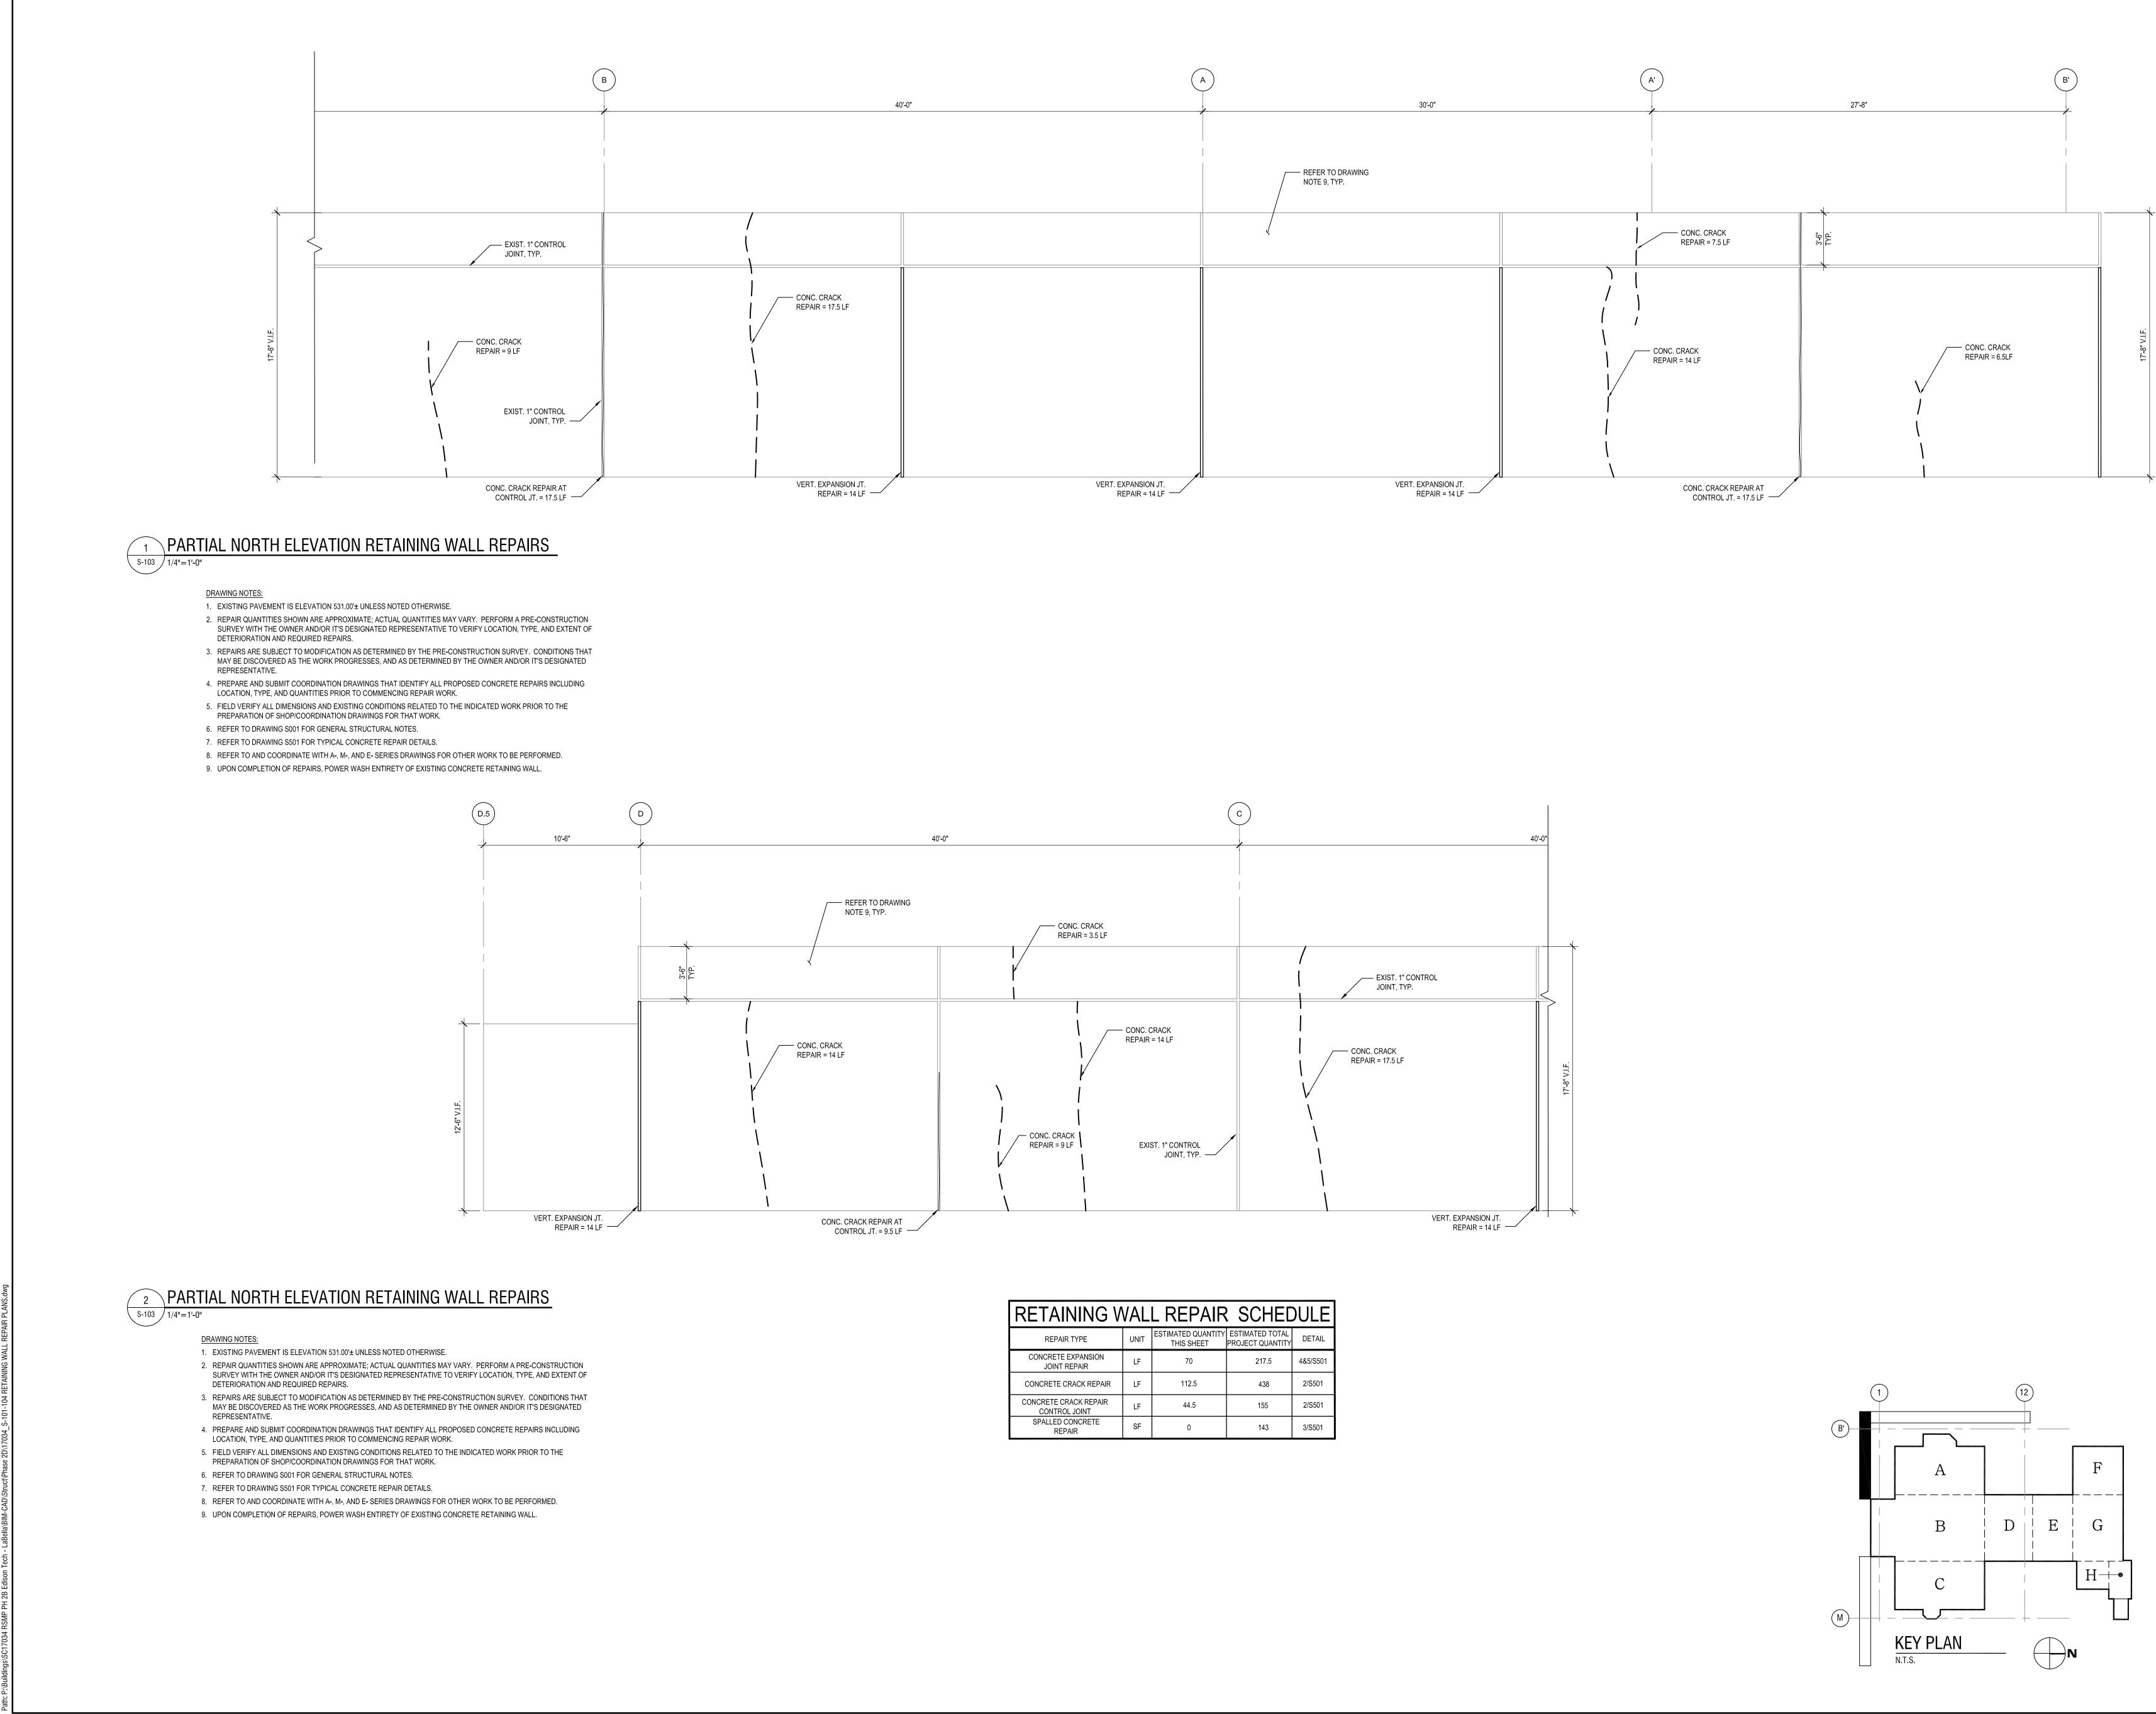

| RETAINING WALL REPAIR SCHEDULE | | | | | | | | | | |
|--|------|----------------------------------|-------------------------------------|----------|--|--|--|--|--|--|
| REPAIR TYPE | UNIT | ESTIMATED QUANTITY THIS SHEET | ESTIMATED TOTAL PROJECT QUANTITY | DETAIL | | | | | | |
| CONCRETE EXPANSION JOINT REPAIR | LF | 70 | 217.5 | 4&5/S501 | | | | | | |
| CONCRETE CRACK REPAIR | LF | 112.5 | 438 | 2/S501 | | | | | | |
| CONCRETE CRACK REPAIR CONTROL JOINT | LF | 44.5 | 155 | 2/S501 | | | | | | |
| SPALLED CONCRETE REPAIR | SF | 0 | 143 | 3/S501 | | | | | | |



DRAWING NUMBER:

NORTH ELEVATION RETAINING WALL REPAIRS

| DATE: | JUN |
|---------------|-----|
| DRAWING NAME: | |

REVISIONS

NO: DATE: DESCRIPTION:

1 6.28.19 BID ADDENDUM 1 PROJECT NUMBER: 2170218 DRAWN BY: ERL REVIEWED BY: JMF ISSUED FOR: BID DOCUMENTS JNE 26, 2019

SED NO. 26-16-00-01-0-111-032 DWT NO. 26-16-00-01-7-999-020

655 COLFAX STREET ROCHESTER, NY 14606

EDISON TECHNICAL SCHOOL

1776 N. CLINTON AVE ROCHESTER, NY 14621

It is a violation of New York Education Law an architect, engineer, or land surveyor is altered; the altering architect, engineer, or land surveyor shall affix to the item their seal and notation "altered by" followed by their signature and date of such alteration, and a specific description of the alteration.

© 2019 LaBella Associates

ROCHESTER SCHOOLS

MODERNIZATION PROGRAM

Article 145 Sec.7209, for any person, unless acting under the direction of a licensed architect, professional engineer, or land surveyor, to alter an item in any way. If an item bearing the seal of

2060 FAIRPORT-NINE MILE FOINT ROAD, SUITE PENTIFILD, NY 14520 PHONE: 585.377.3550 • FAX: 585.377.3559 555 Penbrooke Drive • Pentield, NY 14526 main: 585.388.2060 • fax: 585.388.2070




Powered by pa

300 State Street, Suite 201

Rochester, NY 14614

585-454-6110

labellapc.com

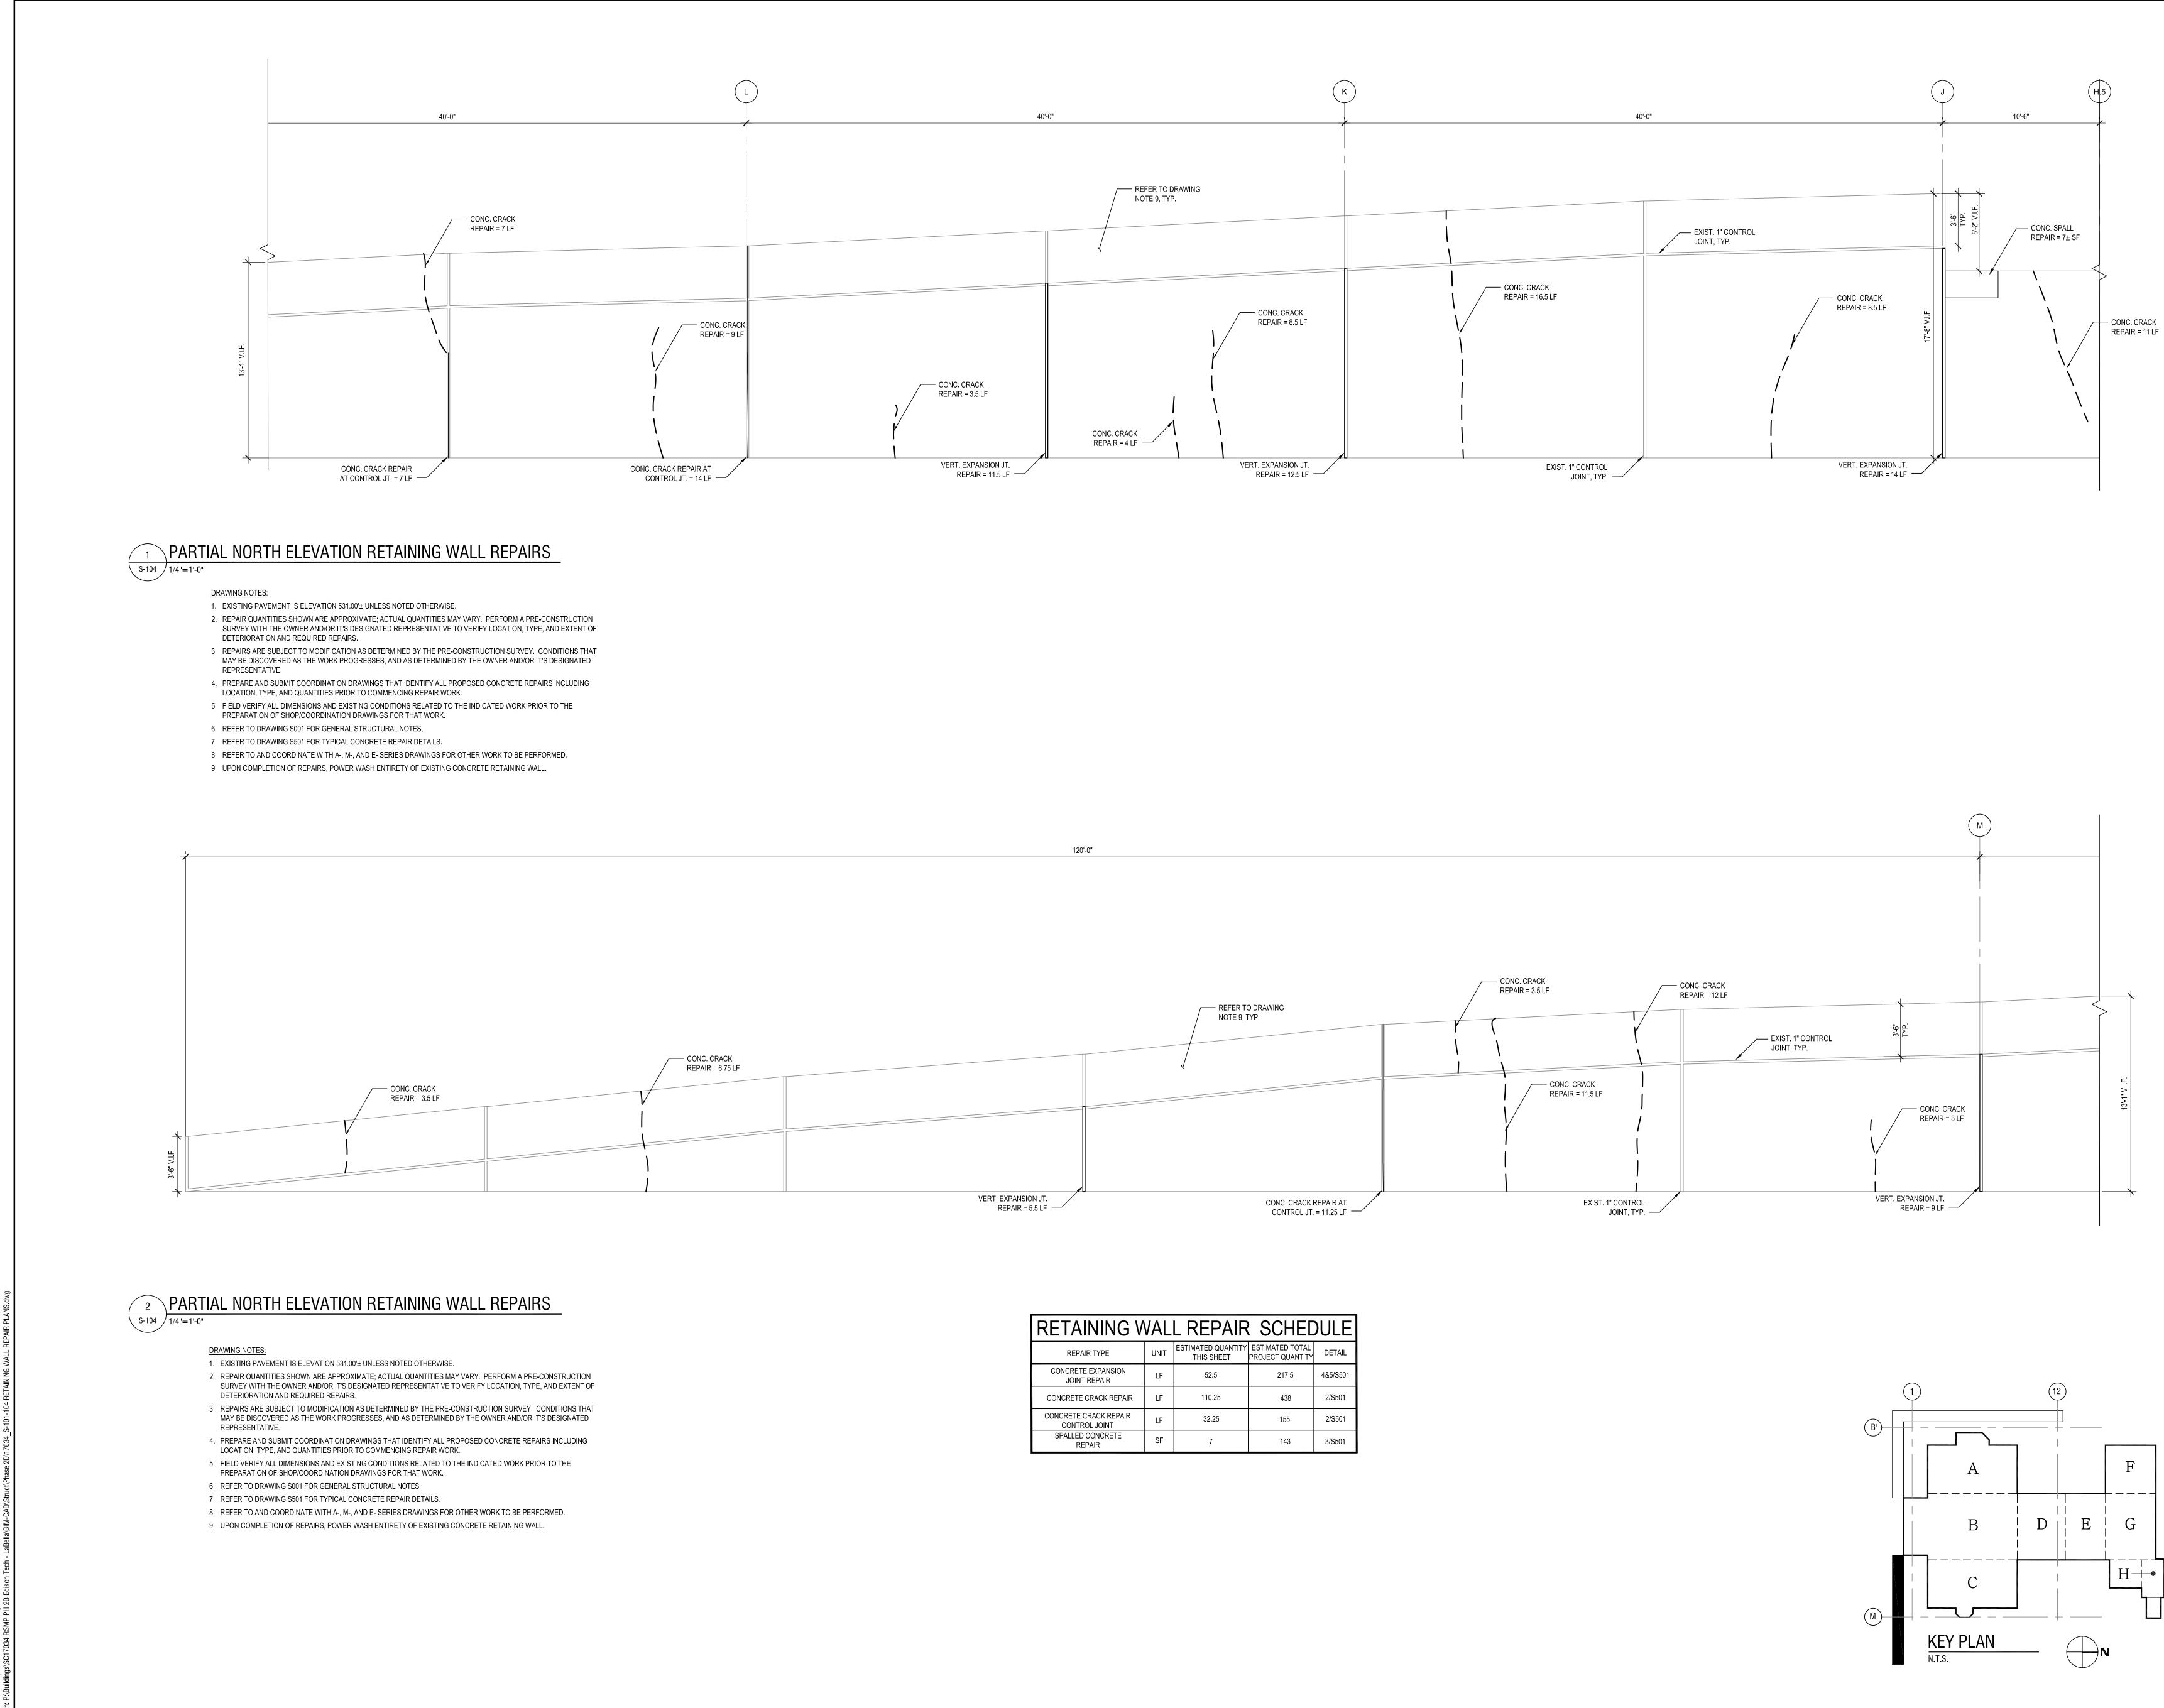

| RETAINING WALL REPAIR SCHEDULE | | | | | | | | | | |
|--|------|----------------------------------|-------------------------------------|----------|--|--|--|--|--|--|
| REPAIR TYPE | UNIT | ESTIMATED QUANTITY THIS SHEET | ESTIMATED TOTAL PROJECT QUANTITY | DETAIL | | | | | | |
| CONCRETE EXPANSION JOINT REPAIR | LF | 52.5 | 217.5 | 4&5/S501 | | | | | | |
| CONCRETE CRACK REPAIR | LF | 110.25 | 438 | 2/S501 | | | | | | |
| CONCRETE CRACK REPAIR CONTROL JOINT | LF | 32.25 | 155 | 2/S501 | | | | | | |
| SPALLED CONCRETE REPAIR | SF | 7 | 143 | 3/S501 | | | | | | |



DRAWING NUMBER:

DRAWING NAME:

NORTH ELEVATION RETAINING WALL REPAIRS

| D | DWT NO. 26-16-00-01-7-999-020 | | | | | | | | | | |
|------------------------------|-------------------------------|----------------|--|--|--|--|--|--|--|--|--|
| REVISIONS | | | | | | | | | | | |
| NO: | NO: DATE: DESCRIPTION: | | | | | | | | | | |
| 1 | 6.28.19 | BID ADDENDUM 1 | | | | | | | | | |
| | | | | | | | | | | | |
| | | | | | | | | | | | |
| | | | | | | | | | | | |
| PROJECT | NUMBER: | 2170218 | | | | | | | | | |
| DRAWN BY | /. | ERL | | | | | | | | | |
| REVIEWED | BY: | JMF | | | | | | | | | |
| ISSUED FOR: BID DOCUMENTS | | | | | | | | | | | |
| DATE: | DATE: JUNE 26, 2019 | | | | | | | | | | |

SED NO. 26-16-00-01-0-111-032

655 COLFAX STREET

ROCHESTER, NY 14606

EDISON TECHNICAL SCHOOL

ROCHESTER, NY 14621

© 2019 LaBella Associates **ROCHESTER SCHOOLS MODERNIZATION PROGRAM** 1776 N. CLINTON AVE

It is a violation of New York Education Law Article 145 Sec.7209, for any person, unless acting under the direction of a licensed architect, professional engineer, or land surveyor, to alter an item in any way. If an item bearing the seal of an architect, engineer, or land surveyor is altered; the altering architect, engineer, or land surveyor shall affix to the item their seal and notation "altered by" followed by their signature and date of such alteration, and a specific description of the alteration.

ak Associates 2000 FAIRPORT-NINE MILE POINT ROAD, SUITH 4. PENTIFILD, NY 14520 PHONE: 685.377.3550 • FAX: 685.377.3559 EOI 555 Penbrooke Drive • Penfield, NY 14526 main: 585.388.2060 • fax: 585.388.2070


labellapc.com RSM in association with

300 State Street, Suite 201

Rochester, NY 14614

585-454-6110

Powered by partnership

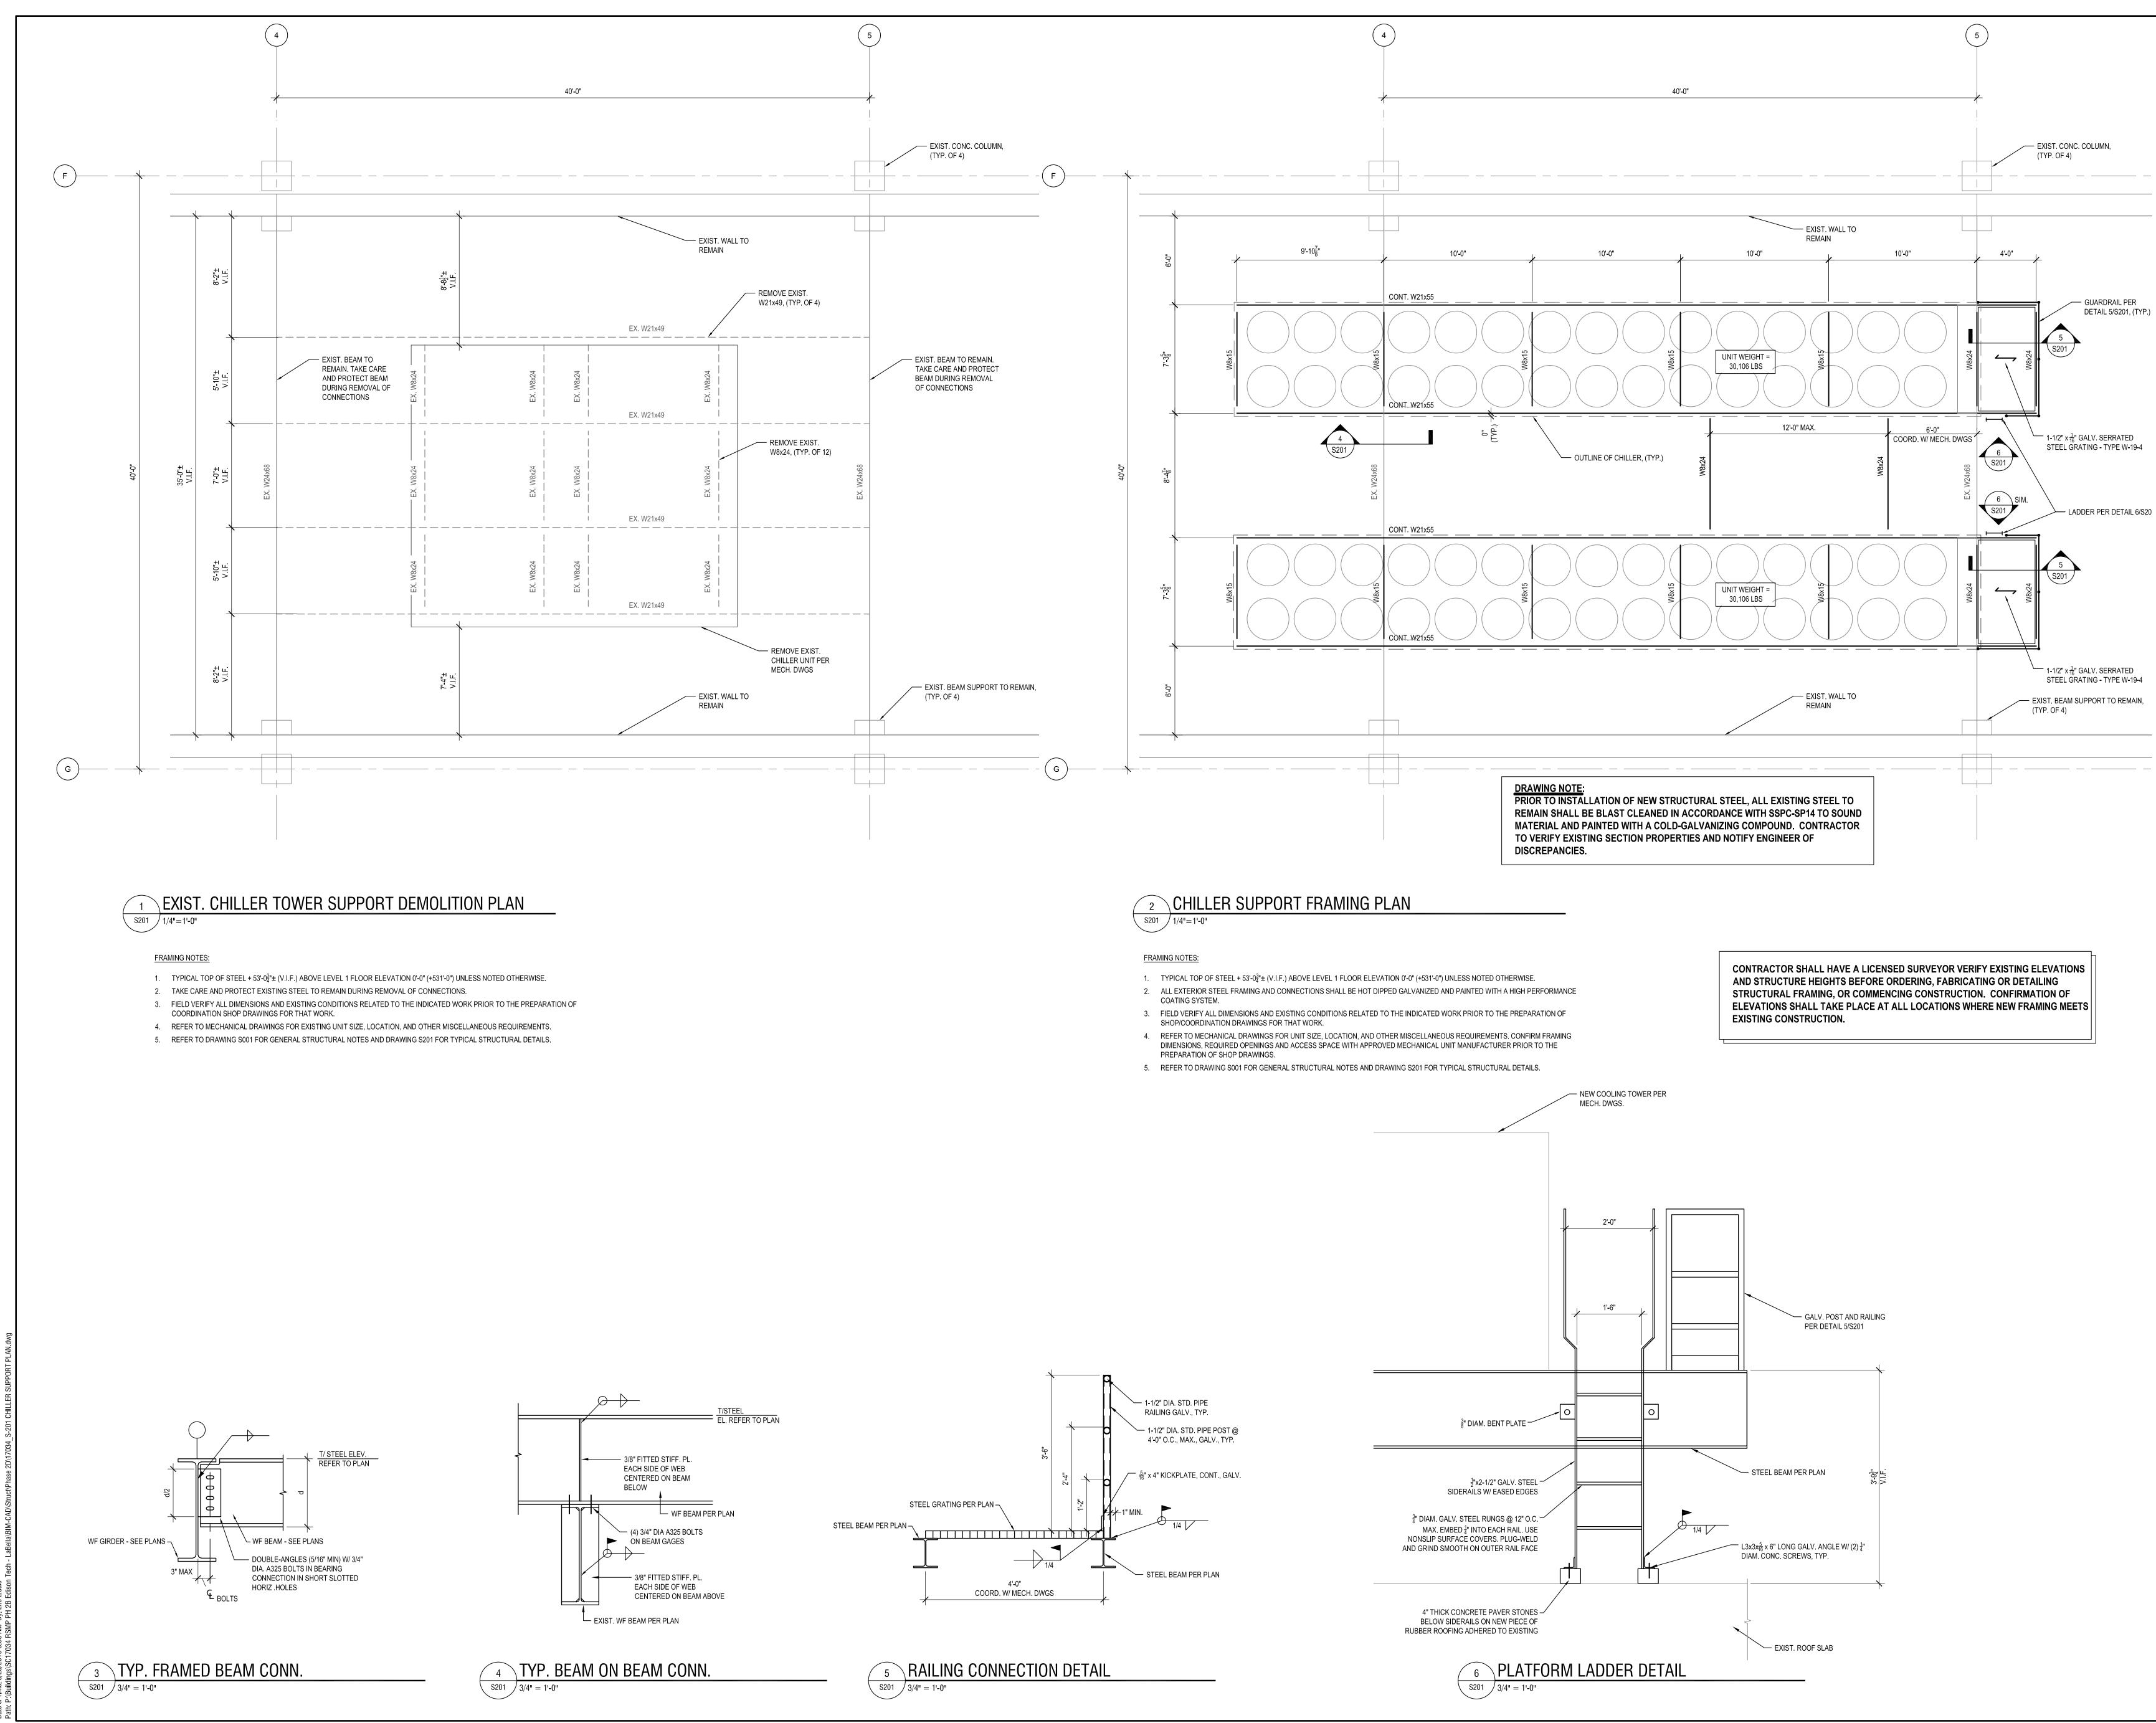



DRAWING NUMBER:

DRAWING NAME:

CHILLER SUPPORT DEMOLITION AND FRAMING PLANS

| D | | | | | | | | | | |
|------------------------------|--------------------------|---------|---|--|--|--|--|--|--|--|
| REVISION | S | | - | | | | | | | |
| NO: DATE: DESCRIPTION: | | | | | | | | | | |
| 1 | 1 6.28.19 BID ADDENDUM 1 | | | | | | | | | |
| | | | - | | | | | | | |
| | | | _ | | | | | | | |
| | | | _ | | | | | | | |
| PROJECT N | IUMBER: | | | | | | | | | |
| | | 2170218 | | | | | | | | |
| DRAWN BY | · | ERL | - | | | | | | | |
| REVIEWED | BY: | JMF | | | | | | | | |
| ISSUED FOR: BID DOCUMENTS | | | | | | | | | | |
| DATE: | DATE: JUNE 26, 2019 | | | | | | | | | |

SED NO. 26-16-00-01-0-111-032 DWT NO. 26-16-00-01-7-999-020

655 COLFAX STREET ROCHESTER, NY 14606

EDISON TECHNICAL SCHOOL

1776 N. CLINTON AVE

ROCHESTER, NY 14621

and date of such alteration, and a specific description of the alteration. © 2019 LaBella Associates **ROCHESTER SCHOOLS MODERNIZATION PROGRAM**

notation "altered by" followed by their signature

It is a violation of New York Education Law Article 145 Sec.7209, for any person, unless acting under the direction of a licensed architect, professional engineer, or land surveyor, to alter an item in any way. If an item bearing the seal of an architect, engineer, or land surveyor is altered, the altering architect, engineer, or land surveyor shall affix to the item their seal and





300 State Street, Suite 201

Rochester, NY 14614

585-454-6110

labellapc.com

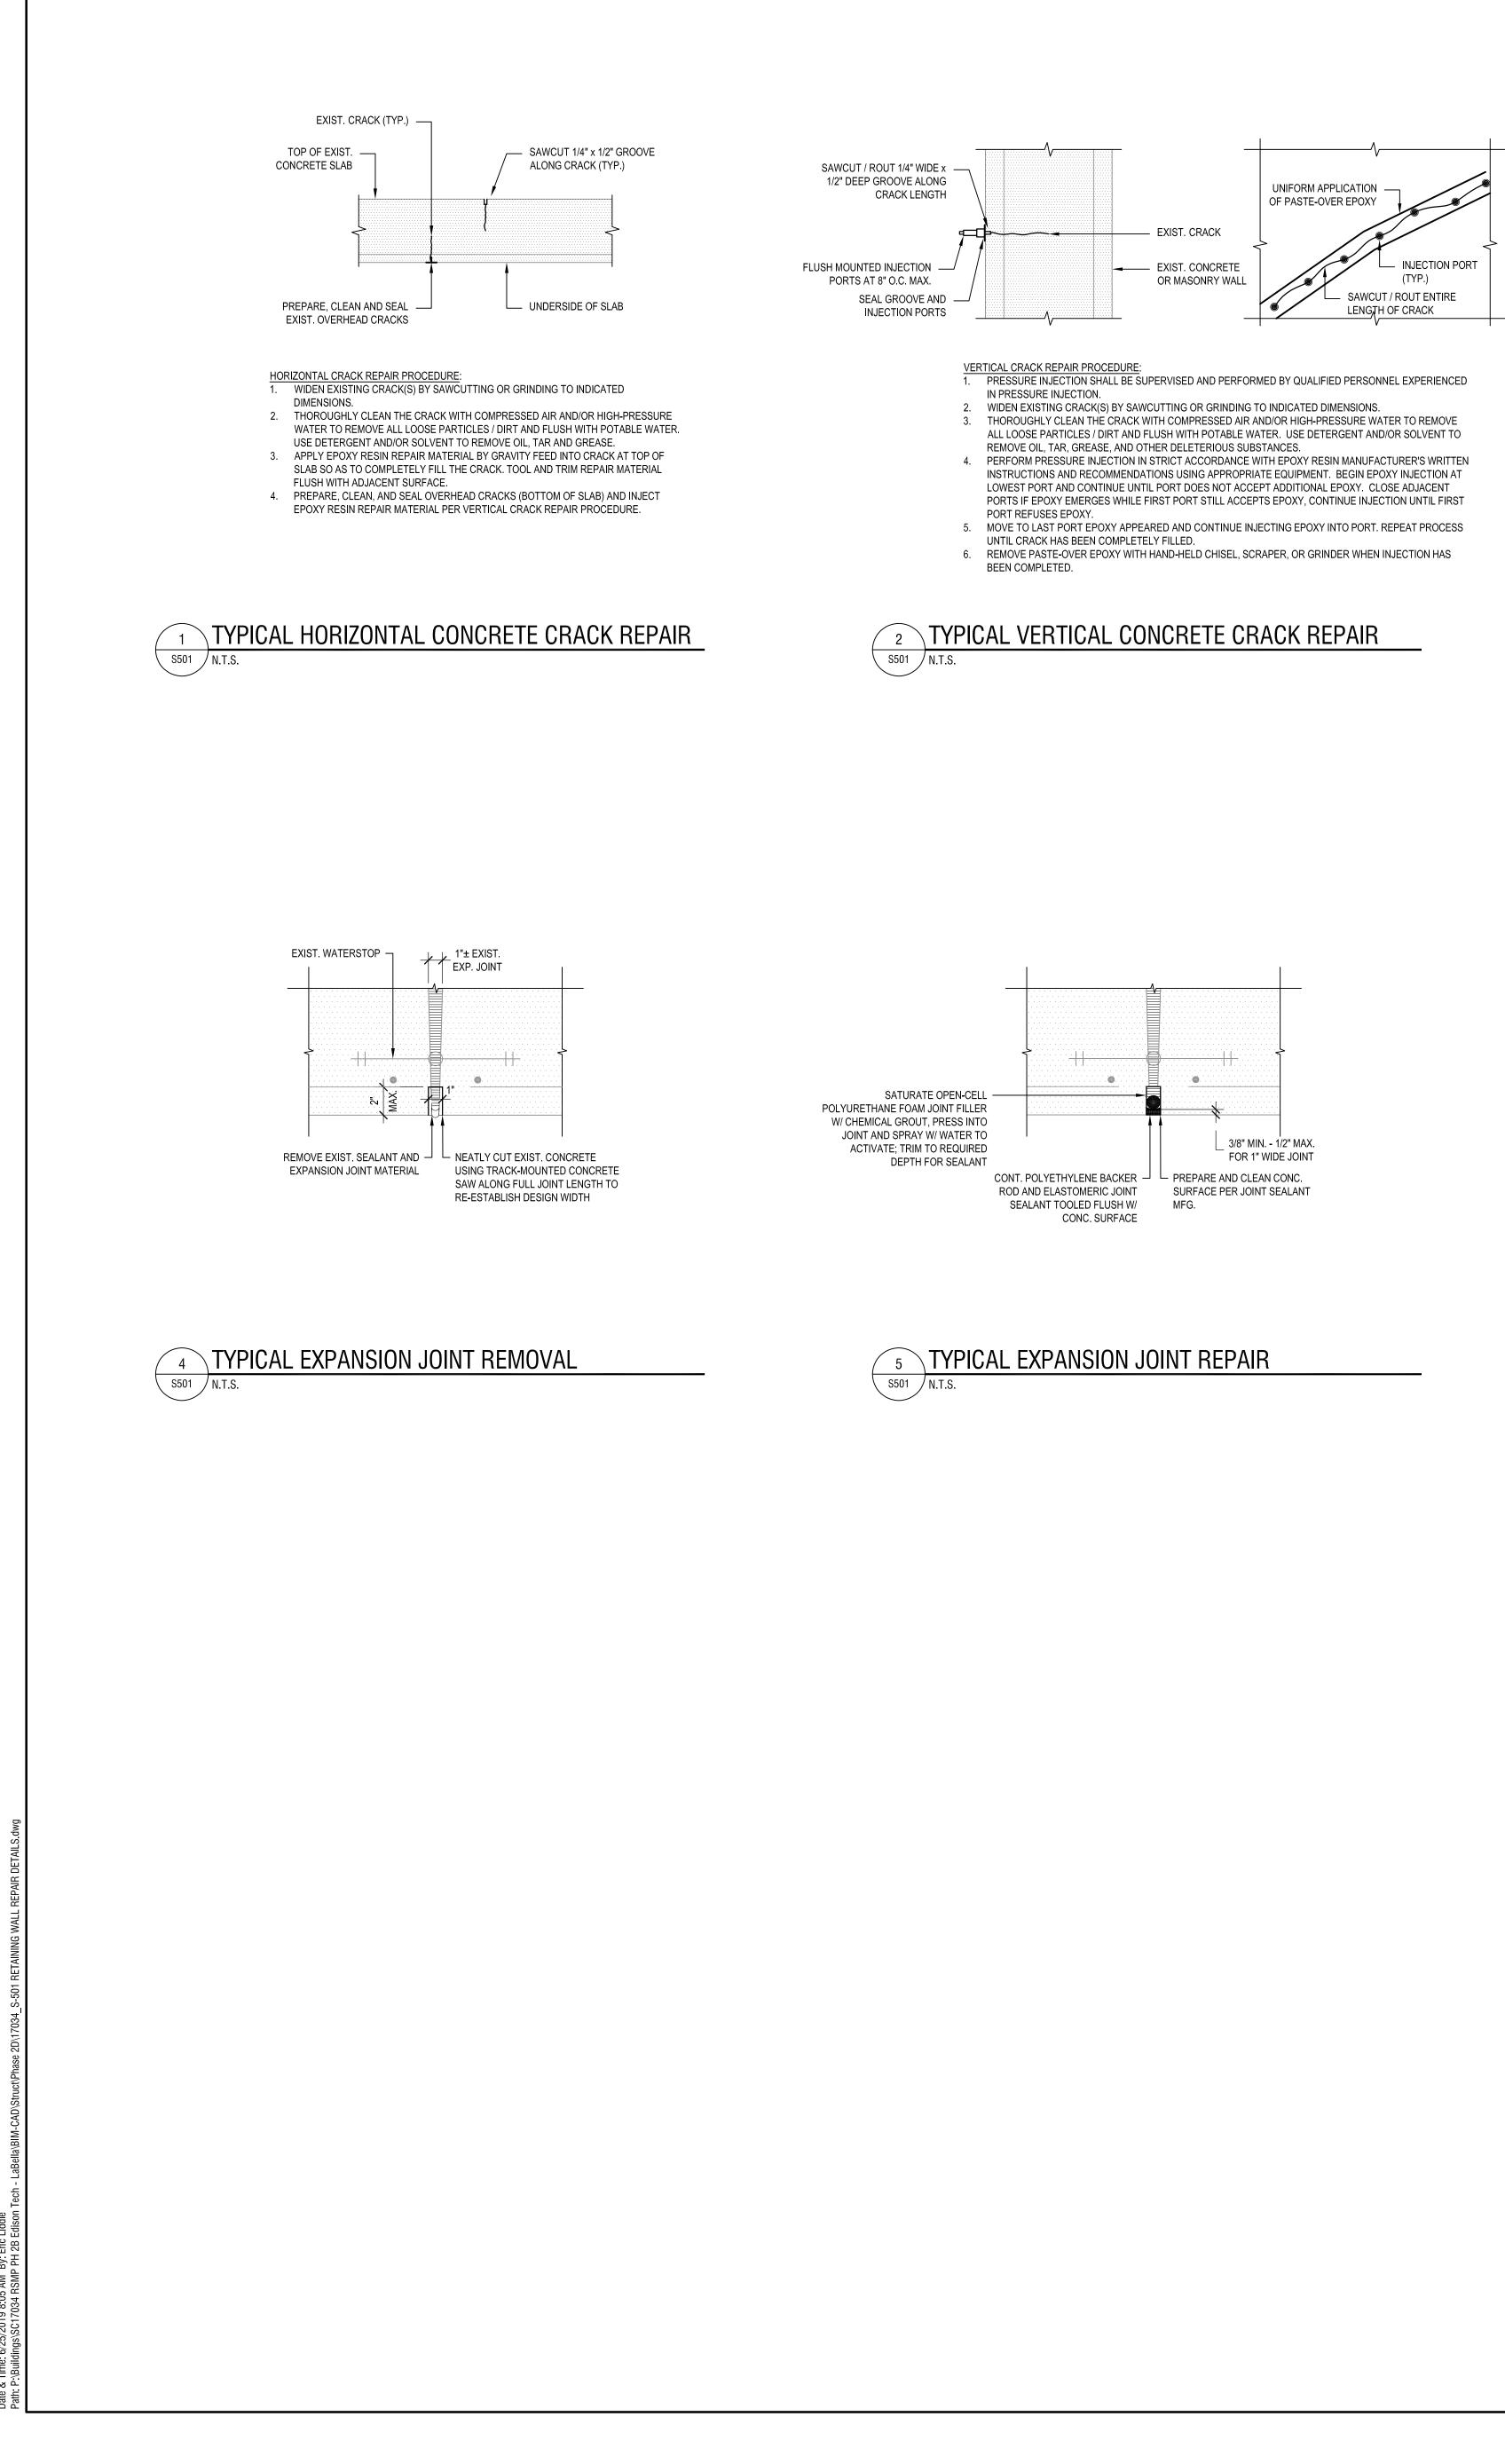

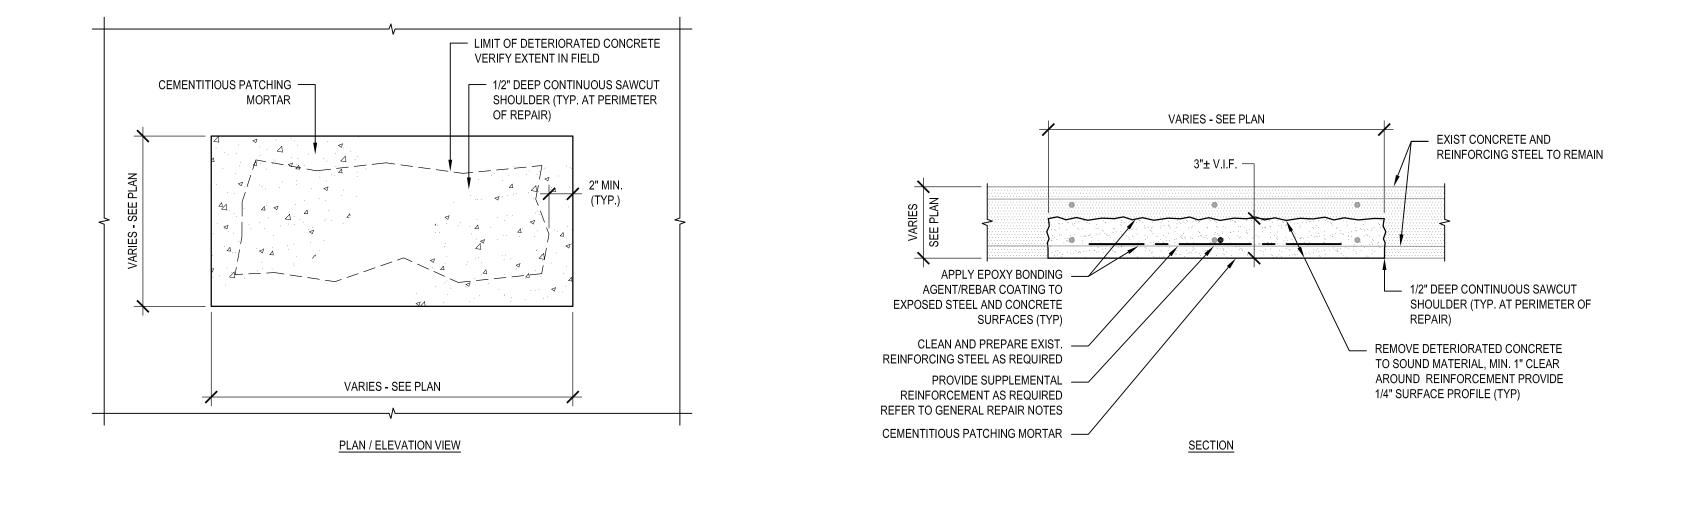





| I | | 1 | | I |
|--|---|---|--|--|
| | | | | |
| Article 14 acting unde profession an item in a an arch altered; th surveyor notation "a and date | 5 Sec.720 or the direct any way. If itect, engin e altering a shall affix iltered by" | 9, for any ction of a r, or land an item t neer, or la architect, to the ite followed alteration, | and surveyc engineer, c m their sea by their sign and a spec | nless chitect, o alter seal of or is or land l and nature |
| | © 2019 L | _aBella Associ | ates | |
| MODEF | | TION CLINTOR | N AVE | |
| | ON TEC 655 COL ROCHEST | FAX STF | |)L |
| - | | | -0-111-03 -7-999-02 | |

—

REVISIONS NO: DATE: DESCRIPTION: 1 6.28.19 BID ADDENDUM 1 _____ _____ PROJECT NUMBER: 2170218 DRAWN BY: ERL REVIEWED BY: JMF ISSUED FOR: BID DOCUMENTS DATE: JUNE 26, 2019

DRAWING NAME:

RETAINING WALL REPAIR DETAILS



| <u> </u> | LECTRICAL GENERAL NOTES: |
|----------|---|
| A | ELECTRICAL CONTRACTOR SHALL COORDINATE ALL ELECTRICAL DEVICE PLACEMENT AND ELEVATIONS WITH CASEWORK SUPPLIER ANDA ARCHITECT PRIOF TO ROUGH-IN. GENERAL CONTRACTOR SHALL PROVIDE ALL DRILLING AND GROMMETING IN CASEWORK FOR CORD ACCESS IF REQUIRED. |
| В | COORDINATE LOCATIONS OF ALL RECEPTACLES IN MECHANICAL SPACES WITH HVA CONTRACTOR TO AVOID CONFLICTS WITH EQUIPMENT. |
| С | COORDINATE LOCATION OF LIGHT FIXTURES IN MECHANICAL SPACES WITH HVAC EQUIPMENT AND DUCT WORK. |
| D | ALL EXPOSED CONDUIT/J-BOXES NEED TO BE PREPPED FOR PAINTING BY OTHERS. |
| E | PROVIDE FIRE-PROOFING SEALANT FOR ANY PENETRATIONS THROUGH FIRE-SAFE WALLS. |
| E | <u>CLOSE-OUT</u> . PROJECT PROVIDE TRAINING FOR APPROPRIATE DISTRICT PERSONNEL. TRAINING WILL REVIEW COMPLETE OPERATIONS AND MAINTENANCE (0&M) MANUAL, INCLUDING BUT NOT LIMITED TO, PROGRAMMING AND SETUP OF ANY CONTROL SYSTEMS, REQUIRED MAINTENANCE, AND TROUBLESHOOTING, INCLUDING CONTACT NAMES AND PHONE NUMBERS FOR FACTORY SUPPORT. |
| F | OUTAGES. A MINIMUM OF SEVEN CALENDAR DAYS, IN ADVANCE, COORDINATE ALL ELECTRICAL SERVICE OUTAGES WITH THE DISTRICT AND THE POWER COMPANY. CONFIRM OUTAGE TIMES WITH RCSD REPRESENTATIVE, IN ADVANCE, A MINIMUM OF 48 HOURS. PLAN ALL WORK SO THAT THE DURATION OF OUTAGE IS KEPT TO AN ABSOLUTE MINIMUM. PROVIDE TEMPORARY WIRING AS REQUIRED IN ORDER TO MAINTAIN CONTINUOUS SERVICE TO OCCUPIED PORTIONS OF THE BUILDING DURING BUSINESS HOURS. |
| 3 | <u>SALVAGE.</u> RCSD HAS FIRST RIGHTS OF SALVAGE FOR EQUIPMENT AND MATERIALS REMOVED DURING CONSTRUCTION. COORDINATE PROJECT SPECIFIC DETAILS WITH THE RCSD REPRESENTATIVE. |
| E | LECTRICAL GENERAL DEMOLITION NOTES: |
| | LECTRICAL GENERAL DEMOLITION NOTES: THIS CONTRACTOR SHALL REMOVE ONLY EXISTING ELECTRIC ITEMS IN AREAS OF RENOVATIONS, UNLESS OTHERWISE NOTED, TO ACCOMMODATE THE NEW CONSTRUCTION. REROUTING OF EXISTING MAY BE REQUIRED AT NEW OPENINGS IN EXISTING CONSTRUCTION OR INTERFERENCE WITH OTHER NEW WORK, AS NOTED BELOW. |
| <u>Ε</u> | THIS CONTRACTOR SHALL REMOVE ONLY EXISTING ELECTRIC ITEMS IN AREAS OF RENOVATIONS, UNLESS OTHERWISE NOTED, TO ACCOMMODATE THE NEW CONSTRUCTION. REROUTING OF EXISTING MAY BE REQUIRED AT NEW OPENINGS IN EXISTING CONSTRUCTION OR INTERFERENCE WITH OTHER |
| 4 | THIS CONTRACTOR SHALL REMOVE ONLY EXISTING ELECTRIC ITEMS IN AREAS OF RENOVATIONS, UNLESS OTHERWISE NOTED, TO ACCOMMODATE THE NEW CONSTRUCTION. REROUTING OF EXISTING MAY BE REQUIRED AT NEW OPENINGS IN EXISTING CONSTRUCTION OR INTERFERENCE WITH OTHER NEW WORK, AS NOTED BELOW. DRAWINGS INDICATE SPECIFIC ITEMS TO BE REMOVED AND/OR RELOCATED IN ORDER TO INDICATE GENERAL SCOPE. WIRING & CIRCUITRY ARE NOT SHOW BUT SHALL BE INCLUDED. THE ELECTRICAL CONTRACTOR SHALL REMOVE, RELOCATE, OR REROUTE ADDITIONAL ITEMS NOT INDICATED BUT NECESSARY FOR PROJECT RENOVATIONS. THEREFORE, THE ELECTRICAL CONTRACTOR SHALL ASSUME WITHIN HIS BASE BID A NOMINAL AMOUNT OF UNKNOWN BRANCH CIRCUITS, FIXTURES, DEVICES, AND SYSTEMS WIRING, WITHIN WALLS |
| З | THIS CONTRACTOR SHALL REMOVE ONLY EXISTING ELECTRIC ITEMS IN AREAS OF RENOVATIONS, UNLESS OTHERWISE NOTED, TO ACCOMMODATE THE NEW CONSTRUCTION. REROUTING OF EXISTING MAY BE REQUIRED AT NEW OPENINGS IN EXISTING CONSTRUCTION OR INTERFERENCE WITH OTHER NEW WORK, AS NOTED BELOW. DRAWINGS INDICATE SPECIFIC ITEMS TO BE REMOVED AND/OR RELOCATED IN ORDER TO INDICATE GENERAL SCOPE. WIRING & CIRCUITRY ARE NOT SHOW BUT SHALL BE INCLUDED. THE ELECTRICAL CONTRACTOR SHALL REMOVE, RELOCATE, OR REROUTE ADDITIONAL ITEMS NOT INDICATED BUT NECESSARY FOR PROJECT RENOVATIONS. THEREFORE, THE ELECTRICAL CONTRACTOR SHALL ASSUME WITHIN HIS BASE BID A NOMINAL AMOUNT OF UNKNOWN BRANCH CIRCUITS, FIXTURES, DEVICES, AND SYSTEMS WIRING, WITHIN WALLS OR OPENINGS BEING REMOVED OR RELOCATIONS REQUIRED FOR NEW WORK. WHERE DEVICES, FIXTURES, ETC. ARE INDICATED TO BE REMOVED, THEY AND THEIR RELATED WIRING/CONDUIT, ALL SUPPORT SHALL BE REMOVED BACK TO THE SOURCE PANELBOARD. IF CIRCUITS ARE FOUND THAT HAVE OTHER ITEMS ON THEM THAT ARE TO REMAIN, THESE CIRCUITS SHALL REMAIN. MAINTAIN CIRCUIT CONTINUITY TO FEED THRU TO ANY REMAINING DEVICES, FIXTURES, EQUIPMENT, ETC. RELOCATE ANY CIRCUITS THAT ARE TO REMAIN, AS REQUIRED, TO AVOID CONFLICT WITH NEW CONSTRUCTION. PROPERLY |
| A | THIS CONTRACTOR SHALL REMOVE ONLY EXISTING ELECTRIC ITEMS IN AREAS OF RENOVATIONS, UNLESS OTHERWISE NOTED, TO ACCOMMODATE THE NEW CONSTRUCTION. REROUTING OF EXISTING MAY BE REQUIRED AT NEW OPENINGS IN EXISTING CONSTRUCTION OR INTERFERENCE WITH OTHER NEW WORK, AS NOTED BELOW. DRAWINGS INDICATE SPECIFIC ITEMS TO BE REMOVED AND/OR RELOCATED IN ORDER TO INDICATE GENERAL SCOPE. WIRING & CIRCUITRY ARE NOT SHOW BUT SHALL BE INCLUDED. THE ELECTRICAL CONTRACTOR SHALL REMOVE, RELOCATE, OR REROUTE ADDITIONAL ITEMS NOT INDICATED BUT NECESSARY FOR PROJECT RENOVATIONS. THEREFORE, THE ELECTRICAL CONTRACTOR SHALL ASSUME WITHIN HIS BASE BID A NOMINAL AMOUNT OF UNKNOWN BRANCH CIRCUITS, FIXTURES, DEVICES, AND SYSTEMS WIRING, WITHIN WALLS OR OPENINGS BEING REMOVED OR RELOCATIONS REQUIRED FOR NEW WORK. WHERE DEVICES, FIXTURES, ETC. ARE INDICATED TO BE REMOVED, THEY AND THEIR RELATED WIRING/CONDUIT, ALL SUPPORT SHALL BE REMOVED BACK TO THE SOURCE PANELBOARD. IF CIRCUITS ARE FOUND THAT HAVE OTHER ITEMS ON THEM THAT ARE TO REMAIN, THESE CIRCUITS SHALL REMAIN. MAINTAIN CIRCUIT CONTINUITY TO FEED THRU TO ANY REMAINING DEVICES, FIXTURES, EQUIPMENT, ETC. RELOCATE ANY CIRCUITS THAT ARE TO REMAIN, AS REQUIRED, TO AVOID CONFLICT WITH NEW CONSTRUCTION. PROPERLY TERMINATE ALL WIRING. |

ELECTRICAL ARREVIATIONS

| ELECTRIC | CAL ABBREVIATIONS | | | | | SYMBOL LIST | |
|--------------|--|---------------|--|--------------|---|--|--|
| AFF | ABOVE FINSIHED FLOOR | SD | SMOKE DAMPER | | LIGHTING | POWER | |
| AFG | ABOVE FINISHED GRADE | | SHUNT TRIP | | LUMINAIRE, TYPE INDICATED IN CAPITAL LETTER | | — – – — LOW VOLTAGE CONTROL WIRING BETWEEN DEVICES |
| ATS BLDG. | AUTOMATIC TRANSFER SWITCH BUILDING | SWBD TVSS | SWITCHBOARD TRANSIENT VOLTAGE SURGE SUPPRESSOR | | LOWINAIRE, TYPE INDICATED IN CAPITAL LETTER LOWER CASE LETTER INDICATES SWITCHING CIRCUIT REFER TO LUMINAIRE SCHEDULE FOR DESCRIPTION | SINGLE RECEPTACLE, 2P, 3W, 20AMP, 120VAC. C - INDICATES ABOVE COUNTER. COORDINATE WITH G.C. UC - INDICATES UNDER COUNTER. COORDINATE WITH G.C. | CONDUIT AND WIRING BELOW GRADE OR FINISHED FLOOR |
| C CB | CONDUIT (OR "COVER" WHEN NEXT TO A FIRE ALARM DEVICE) CIRCUIT BREAKER | | UNLESS OTHERWISE INDICATED | Опю | | WC - INDICATES UNDER COOLER RECEPTACLE. COORDINATE WITH G.C. WC - INDICATES WATER COOLER RECEPTACLE. COORDINATE WITH P.C. V - INDICATES VENDING MACHINE RECEPTACLE | CONDUIT AND WIRING FOR EMERGENCY CIRCUIT. 2 #12 AWG IN 1/2 CONDUIT UNLESS OTHERWISE INDICATED. |
| CKT. | CIRCUIT | VFD | VARIABLE FREQUENCY DRIVE | XX | LUMINAIRE CONNECTED TO LOCAL UNSWITCHED | TV - INDICATES TELEVISION/MONITOR OUTLET AT CEILING IG - INDICATES ISOLATED GROUND TYPE | 10 HOME RUN TO PANEL. CIRCUIT NUMBER INDICATED |
| DISC | DISCONNECT SWITCH | VOIP | VOICE OVER IP | | LIGHTING CIRCUIT. | + xx" INDICATES HEIGHT OF RECEPTACLE ABOVE FINISHED FLOOR EX - INDICATES EXISTING DEVICE | |
| E.C. | ELECTRICAL SUB CONTRACTOR | W | WIRE | £ | EMERGENCY LIGHT | M - INDICATES MICROWAVE RECEPTACLE | $\left\langle \begin{array}{c} LP \end{array} \right\rangle$ PANELBOARD DESIGNATION |
| ECB | ENCLOSED CIRCUIT BREAKER | WG | WIRE GUARD (OR "W" IF NEXT TO A FIRE ALARM DEVICE) | Ţ | SITE LIGHTING FIXTURE | P - INDICATES PROJECTOR RECEPTACLE AT CEILING R - INDICATES REFRIGERATOR RECEPTACLE | BRANCH CIRCUIT PANELBOARD, 208Y/120V, 3Ø, 4W |
| EMT | ELECTRIC METAL TUBING | WP | EQUIPMENT/MATERIAL TO BE WEATHERPROOF TYPE | • | REFER TO SITE LIGHTING SCHEDULE FOR DESCRIPTION | USB -INDICATES RECEPTACLE WITH USB PORT | |
| ER ETR | INDICATES REMOVE EXISTING DEVICE AND RELOCATE EXISTING TO REMAIN | WSA | WIRE SIZING AMPS | ΗQ | EXIT LIGHT, WALL MOUNT, DIRECTIONAL ARROWS AS INDICATED ON PLANS | UPLEX RECEPTACLE, GFCI PROTECTED C - INDICATES ABOVE SINK OR COUNTER. COORDINATE WITH G.C. | DISTRIBUTION PANELBOARD , NOMINAL 600V RATING, 3φ, 4W |
| EX | EXISTING | | | \bigotimes | EXIT LIGHT, CEILING MOUNT, DIRECTIONAL ARROWS AS INDICATED ON PLANS | WP - INDICATES WEATHERPROOF COVER +xx" - INDICATES HEIGHT OF RECEPTACLE | EZZZ BRANCH CIRCUIT PANELBOARD, 480Y/277V , 3φ, 4W |
| FA | FIRE ALARM | | DEMOLITION LEGEND | | | UUADPLEX RECEPTACLE; 2P, 3W, 20 AMP, 120 VAC, GFCI | |
| FACP | FIRE ALARM CONTROL PANEL | | | \$a | SWITCH, TOGGLE, 20 AMP, 120 VAC, SINGLE CIRCUIT a - INDICATES SWITCHING DESIGNATION | FLOOR RECEPTACLE/OUTLET | LIGHTNING PROTECTION |
| FAAP | FIRE ALARM ANNUNCIATOR PANEL | г | RECESSED LIGHT FIXTURE | \$ab | SWITCH, TOGGLE, 20 AMP, 120 VAC, TWO CIRCUIT | | |
| G.C. | GENERAL CONTRACTOR | <u></u> | | \$L | SWITCH, LOW VOLTAGE | | AT O COPPER AIR TERMINAL |
| GND, GR | GROUND | \$ | DUPLEX RECEPTACLE | \$° | SWITCH, OCCUPANCY SENSING TYPE, SINGLE CIRCUIT | T TRANSFORMER AS SCHEDULED | GROUND ROD CONNECTION |
| HP | HORSEPOWER | \$ | LIGHT SWITCH | T I O | WATT STOPPER #WS-120 OR EQUAL | M MOTOR RATED SWITCH, 120V, 20A | = |
| JB KVA | JUNCTION BOX KILOVOLT AMPERES | ÷. | GFCI OUTLET | \$ab | SWITCH, OCCUPANCY SENSING TYPE, TWO CIRCUIT | ⁰⊠ MAGNETIC STARTER, NEMA SIZE INDICATED | BOND CONNECTION TO COPPER CABLE |
| KVA KW | KILOWATT | ₹7 | TELEPHONE JACK | LTD | UL924 LOAD TRANSFER DEVICE- PROVIDE LOCAL SWITCHED AND UNSWITCHED | ³⁰ DISCONNECT SWITCH, NON-FUSIBLE | BASKET WEAVE COPPER CABLE |
| LCP | LIGHTING CONTROL PANEL | ۲ | SPECIAL PURPOSE OUTLET | | CIRCUITRY AS WELL AS UNSWITCHED | SWITCH SIZE INDICATED | |
| MCA | MINIMUM CIRCUIT AMPACITY | ٢ | SMOKE DETECTOR | | EMERGENCY CIRCUITRY TO DEVICE, TO POWER ALL EMERGENCY FIXTURES IN SPACE | DISCONNECT SWITCH, FUSIBLE FUSE/SWITCH SIZE INDICATED | |
| MCB | | | SURFACE MOUNTED LIGHT | _ | | | |
| MCC MLO | MOTOR CONTROL CENTER MAIN LUGS ONLY | | • | CS | OCCUPANCY SENSOR, CEILING MOUNTED PROVIDE POWER PACK AS REQUIRED | NON-FUSIBLE NEMA SIZE INDICATED | |
| MEO | MOUNTED | | BOUNDARY OF DEMOLITION | | | 30 🖂 Combination motor starter, fusible | |
| MTG | MOUNTING | (K) | KEY PAD (RETURN TO OWNER) | | | NEMA SIZE /FUSE SIZE INDICATED | |
| (N) | INDICATES NEW DEVICE | S | ELECTRICAL CONTROL DEVICE | | | ECB ENCLOSED CIRCUIT BREAKER, 3POLE, RATING 200 INDICATED | |
| N.C. | NORMALLY CLOSED CONTACT | M | MONITOR | | | C CONTACTOR, 120VAC, NEMA 1 ENCL. | |
| N.O. | NORMALLY OPEN CONTACT | | POWER PANEL | | | NUMBER OF POLES AS REQUIRED. | |
| NIC | NOT IN CONTRACT | [C]> | SECURITY CAMERA (RETURN TO OWNER) | | | M MANUAL MOTOR STARTER | |
| NTS OL | NOT TO SCALE OVERLOAD | - <u>(</u>)_ | EQUIPMENT CONNECTION | | | ① REVERSE ACTING THERMOSTAT FURNISHED BY MECHANICAL CONTRACTOR: INICTALLATION BY | |
| φ | PHASE | | | | | MECHANICAL CONTRACTOR; INSTALLATION BY ELECTRICAL CONTRACTOR | |
| P | POLE | EG | HANDICAPPED PUSH BUTTON | | | FSC FAN SPEED CONTROLLER FURNISHED BY | |
| RECEP. | RECEPTACLE | 6 | MAG LOCK (RETURN TO OWNER) | | | MECHANICAL CONTRACTOR; INSTALLATION BY ELECTRICAL CONTRACTOR | |
| REL | RELOCATE | | | | | | |
| | | | | | | | |
| | | | | | | | |
| | | | | | | | |

| | BUILDING LUMINAIRE SCHEDULE | | | | | | | | | | | |
|------|------------------------------|-----------|--------------|-------------|-----------|------|--------|--------------|-----------|------------|-----------------------|---|
| TYPE | DESCRIPTION | LAMPS | LUMENS (MIN) | WATTS (MAX) | CRI (MIN) | CCT | DRIVER | DISTRIBUTION | MOUNTING | MT. HEIGHT | DESIGN BASE | REMARKS |
| A | 2X2 RECESSED DIRECT/INDIRECT | WHITE LED | 2,500 | 20.2 | 80 | 4000 | UNV | - | RECESSED | - | | CURVED SHIELDING, 0-10V DIMMING DRIVER EXCEPT IN RESTROOMS AND CORRIDORS |
| В | 4 FT LENSED LED STRIPLIGHT | WHITE LED | 3,805 | 30.6 | 80 | 4000 | UNV | - | SUSPENDED | 10' | METALUX: SNLED LENSED | LENSED, Y TOGGLE ACCESSORY |

| SITE LUMINAIRE SCHEDULE | | | | | | | | | | | POLE | | | |
|-------------------------|--|-------------|-----------------------------------|----------------------|-------------|--|---|-----|-------------|-------------|--|--------|-----------------|-------|
| PE NO. | | AMP TYPE | DESIGN BASE | MIN. LUMEN OUTPUT | WATTS (MAX) | DESCRIPTION | FINISH | CRI | ARRANGEMENT | ACCESSORIES | DESCRIPTION | HEIGHT | MFR/CATALOG # | |
| | | LED | MC GRAW EDISON-GLEON AF-02 SERIES | 12,050 | 110 | EXTRUDED ALUMINUM LED AREA LUMINAIRE, FULL CUTOFF MAST ARM MOUNT, TYPE IV WIDE THROW, IP 66 RATED, DLC LISTED, LM79/LM80 COMPLIANT | Dark Bronze to Match South Lot Luminaires | 80 | SINGLE | PHOTOCELL | | 25 FT | | |
| 3 - | | LED | MC GRAW EDISON-GLEON AF-03 SERIES | 18,000 | 166 | EXTRUDED ALUMINUM LED AREA LUMINAIRE, FULL CUTOFF MAST ARM MOUNT, TYPE IV WIDE THROW, IP 66 RATED,DLC LISTED, LM79/LM80 COMPLIANT | Dark Bronze to Match South Lot Luminaires | 80 | SINGLE | PHOTOCELL | | 25 FT | | |
| - | | LED | MC GRAW EDISON-GLEON AF-02 SERIES | 12,200 | 113 | EXTRUDED ALUMINUM LED AREA LUMINAIRE, FULL CUTOFF MAST ARM MOUNT, TYPE IV FORWARD THROW, IP 66 RATED, DLC LISTED, LM79/LM80 COMPLIANT | Dark Bronze to Match South Lot Luminaires | 80 | SINGLE | PHOTOCELL | | | | 20 FT |
| - | | LED | MC GRAW EDISON-GLEON AF-01 SERIES | 6,300 | 59 | FIELD ADJUSTABLE EXTRUDED ALUMINUM LED AREA LUMINAIRE, TYPE IV WIDE THROW, IP 66 RATED, LM79/LM80 COMPLIANT | Dark Bronze to Match South Lot Luminaires | 80 | SINGLE | PHOTOCELL | 4" SQUARE,STRAIGHT, ALUMINUM, FINISH TO | 15 FT | STREETWORKS SSA | |
| - | | LED | MC GRAW EDISON-GLEON AF-01 SERIES | 6,300 | 59 | FIELD ADJUSTABLE EXTRUDED ALUMINUM LED AREA LUMINAIRE, TYPE IV WIDE THROW, IP 66 RATED, LM79/LM80 COMPLIANT | Dark Bronze to Match South Lot Luminaires | 80 | SINGLE | PHOTOCELL | MATCH HEAD | 12FT | | |
| - | | LED | MC GRAW EDISON-GLEON AF-01 SERIES | 6,300 | 59 | FIELD ADJUSTABLE EXTRUDED ALUMINUM LED AREA LUMINAIRE, TYPE IV WIDE THROW, IP 66 RATED, LM79/LM80 COMPLIANT | dark bronze to Match South Lot Luminaires | 80 | SINGLE | PHOTOCELL | | 20FT | | |
| - | | LED | MC GRAW EDISON-GLEON AF-02 SERIES | 12,050 | 113 | FIELD ADJUSTABLE EXTRUDED ALUMINUM LED AREA LUMINAIRE, TYPE IV WIDE THROW, IP 66 RATED, LM79/LM80 COMPLIANT | Dark Bronze to Match South Lot Luminaires | 80 | SINGLE | PHOTOCELL | | 20FT | 20FT | |
| - | | LED | MC GRAW EDISON-GLEON AF-02 SERIES | 12,050 | 113 | FIELD ADJUSTABLE EXTRUDED ALUMINUM LED AREA LUMINAIRE, TYPE IV WIDE THROW, IP 66 RATED, LM79/LM80 COMPLIANT | Dark Bronze to Match South Lot Luminaires | 80 | SINGLE | PHOTOCELL | | 15FT | | |

 LUMINAIRES TO BE CONTROLLED BY EXISTING BUILDING TIME CLOCK (IN LOADING DOCK) AND OVERRIDE BY INTEGRAL PHOTOSENSING DEVICE SPECIFIED. PROVIDE ONLY (1) PHOTOCELL PER CIRCUIT).
 POLE HEIGHTS ARE BASIS OF DESIGN. WHERE REUSING EXISTING POLE BASES, EXISTING POLE HEIGHT MUST BE MATCH. 3. WHERE EXISTING CIRCUITING IS TO BE REUSED, LUMINAIRES MUST BE ORDERED TO MATCH EXISTING VOLTAGE, PHASING AND CONFIGURATION.

| | | | | | | EQU | IPMENT | CONNECTION | SCHEDULE | | | | |
|----------|--------------------|---------------------|--------|------|--------------|----------------------|--------------------|--|--------------------|--------------------|---------------------------|--------------------|--|
| LABEL | DESCRIPTION | LOCATION | LOAD | FLA | VOLTS, PHASE | FEED | CIRCUIT BREAKER | WIRE & CONDUIT | CONTROLLER TYPE | CONTROLLER SIZE | CONTROLLER ACCESSORIES | DISCONNECT | REMARKS |
| DH-1 | DEHUMIDIFIER | POOL EQUIPMENT ROOM | 2 HP | 23.3 | 480V, 3PH | LP-014, CKT#22,24,26 | 30A-3P | 3#10 AWG AND (1) #10 GND IN 3/4" C | PROVIDED WITH UNIT | N/A | N/A | PROVIDED WITH UNIT | PROVIDE NEW WIRING/CIRCUITING, CIRCUIT BREAKER FOR SIEMENS PANEL, VFD AND DISCONNECT. |
| P-DH-1 | DEHUMIDIFIER PUMP | POOL EQUIPMENT ROOM | 3/4 HP | 1.6 | 480V, 3PH | LP-014,CKT#1,3,5 | 15A-3P | 3#12 AWG AND (1) #12 GND IN 3/4" C | PROVIDED WITH UNIT | N/A | N/A | 15A | PROVIDE NEW WIRING/CIRCUITING, CIRCUIT BREAKER FOR SIEMENS PANEL, VFD AND DISCONNECT. |
| 012-47P | PUMP | POOL EQUIPMENT ROOM | 1/2 HP | 1.1 | 480V, 3PH | MCC 014 | 15A-3P | 3#12 AWG AND (1) #12 GND IN 3/4" C | PROVIDED WITH UNIT | N/A | N/A | 15A | PROVIDE NEW WIRING, DISCONNECT AND SQUARE D OVERCURRENT PROTECTION IN MCC014. PROVIDE ELECTRICAL CONNECTION TO CONTROLLER SUPPLIED BY OTHERS. |
| 014-46P | PUMP | POOL EQUIPMENT ROOM | 3/4 HP | 1.6 | 480V, 3PH | MCC 014 | 15A-3P | 3#12 AWG AND (1) #12 GND IN 3/4" C | PROVIDED WITH UNIT | N/A | N/A | 15A | PROVIDE NEW WIRING, DISCONNECT AND SQUARE D OVERCURRENT PROTECTION IN MCC014. PROVIDE ELECTRICAL CONNECTION TO CONTROLLER SUPPLIED BY OTHERS. |
| EF-1 | EXHAUST FAN | MECHANICAL ROOM | 5 HP | 7.6 | 480V, 3PH | LP-08, CKT #8,10,12 | 15A-3P | 3#12 AWG AND (1) #12 GND IN 3/4" C | PROVIDE ABB VFD | N/A | N/A | 15A | REUSE EXISTING WIRING/CIRCUITING BUT PROVIDE NEW CIRCUIT BREAKER FOR SQUARE D PANEL, VFD AND DISCONNECT. |
| EF-3-37 | EXHAUST FAN | PENTHOUSE 3 | 2 HP | 3.4 | 480V, 3PH | MCC 43 | 15A-3P | 3#12 AWG AND (1) #12 GND IN 3/4" C | PROVIDED WITH UNIT | N/A | N/A | 15A | PROVIDE NEW WIRING, DISCONNECT AND SQUARE D OVERCURRENT PROTECTION IN MCC 43. PROVIDE ELECTRICAL CONNECTION TO CONTROLLER SUPPLIED BY OTHERS. |
| CWP-3 | CHILLER PUMP | MECHANICAL ROOM | 40 HP | 52 | 480V, 3PH | LP-09, CKT #1,3,5 | 90A-3P | 3#4 AWG AND (1) #8 GND IN 1 1/4" C | PROVIDE ABB VFD | N/A | N/A | 100A | PROVIDE NEW WIRING/CIRCUITING, CIRCUIT BREAKER FOR SQUARE D PANEL, VFD AND DISCONNECT. |
| CWP-4 | CHILLER PUMP | MECHANICAL ROOM | 40 HP | 52 | 480V, 3PH | LP-09, CKT #7,9,11 | 90A-3P | 3#4 AWG AND (1) #8 GND IN 1 1/4" C | PROVIDE ABB VFD | N/A | N/A | 100A | PROVIDE NEW WIRING/CIRCUITING, CIRCUIT BREAKER FOR SQUARE D PANEL, VFD AND DISCONNECT. |
| CWP-5 | CHILLER PUMP | MECHANICAL ROOM | 40 HP | 52 | 480V, 3PH | LP-10, CKT# 32,34,36 | 90A-3P | 3#4 AWG AND (1) #8 GND IN 1 1/4" C | PROVIDE ABB VFD | N/A | N/A | 100A | PROVIDE NEW WIRING/CIRCUITING, CIRCUIT BREAKER FOR SQUARE D PANEL, VFD AND DISCONNECT. |
| AHU-E-35 | AIR HANDLING UNIT | MECHANICAL ROOM | 5 HP | 6.6 | 480V, 3PH | MCC 08 | 15A-3P | 3#12 AWG AND (1) #12 GND IN 3/4" C | PROVIDED WITH UNIT | N/A | N/A | 15A | PROVIDE NEW WIRING, DISCONNECT AND SQUARE D OVERCURRENT PROTECTION IN MCC 08. PROVIDE ELECTRICAL CONNECTION TO CONTROLLER SUPPLIED BY OTHERS. |
| AHU-5-31 | AIR HANDLING UNIT | PENTHOUSE 5 | 10 HP | 50 | 480V, 3PH | MCC 45 | 60A-3P | 3#6 AWG AND (1) #10 GND IN 1" C | PROVIDED WITH UNIT | N/A | N/A | PROVIDED WITH UNIT | PROVIDE AN ADDITIONAL 120V/1PH,20A CIRCUIT FROM AVAILABLE SPARES IN NEAREST PANELBOARD. PROVIDE NEW WIRING AND SQUARE D OVERCURRENT PROTECTION IN MCC 45. PROVIDE ELECTRICAL CONNECTION TO CONTROLLER AND DISCONNECT SUPPLIED BY OTHERS. |
| AHU-1-6 | AIR HANDLING UNIT | PENTHOUSE 1 | 10 HP | 54 | 480V, 3PH | MCC 41 | 60A-3P | 3#6 AWG AND (1) #10 GND IN 1" C | PROVIDED WITH UNIT | N/A | N/A | PROVIDED WITH UNIT | PROVIDE NEW WIRING/CIRCUITING AND SQUARE D OVERCURRENT PROTECTION IN MCC 41. PROVIDE ELECTRICAL CONNECTION TO CONTROLLER AND DISCONNECT SUPPLIED BY OTHERS.PROVIDE AN ADDITIONAL 120V/1PH,20A CIRCUIT FROM AVAILABLE SPARES IN NEAREST PANELBOARD. |
| ACC-1 | AIR COOLED CHILLER | ROOF | - | 1098 | 480V, 3PH | MAIN SWITCHGEAR | 1200A-3P | (3) SETS OF 500KCMILAND (1) 3/0 IN 4" C | PROVIDED WITH UNIT | N/A | N/A | PROVIDED WITH UNIT | PROVIDE NEW WIRING AND SIEMENS BPS SWITCH IN MAINSWITCHGEAR. PROVIDE ELECTRICAL CONNECTION TO CONTROLLER AND DISCONNECT SUPPLIED BY OTHERS. REFER TO ELECTRICAL SITE PLAN FOR MAIN SWITCHGEAR LOCATION. |
| ACC-2 | AIR COOLED CHILLER | ROOF | - | 1098 | 480V, 3PH | MAIN SWITCHGEAR | 1200A-3P | (3) SETS OF 500KCMILAND (1) 3/0 IN 4" C | PROVIDED WITH UNIT | N/A | N/A | PROVIDED WITH UNIT | PROVIDE NEW WIRING AND SIEMENS BPS SWITCH IN MAINSWITCHGEAR. PROVIDE ELECTRICAL CONNECTION TO CONTROLLER AND DISCONNECT SUPPLIED BY OTHERS.REFER TO ELECTRICAL SITE PLAN FOR MAIN SWITCHGEAR LOCATION. |
| ACC-3 | AIR COOLED CHILLER | ROOF | - | 105 | 480V, 3PH | MCC 42 | 125A-3P | 3#2 AWG AND (1) #6 GND IN 1 1/2" C | PROVIDED WITH UNIT | N/A | N/A | PROVIDED WITH UNIT | PROVIDE NEW WIRING AND SQUARE D OVERCURRENT PROTECTION IN MCC 42. PROVIDE ELECTRICAL CONNECTION TO CONTROLLER AND DISCONNECT SUPPLIED BY OTHERS. |
| CWP-1 | CHILLER PUMP | PENTHOUSE 1 | 20 HP | 27 | 480V, 3PH | MCC 41 | 60A-3P | 3#6 AWG AND (1) #10 GND IN 1" C | PROVIDE ABB VFD | N/A | N/A | 30A | PROVIDE NEW WIRING, DISCONNECT, CONTROLLER AND SQUARE D OVERCURRENT PROTECTION IN MCC 41. |
| CWP-2 | CHILLER PUMP | PENTHOUSE 1 | 20 HP | 27 | 480V, 3PH | MCC 41 | 60A-3P | 3#6 AWG AND (1) #10 GND IN 1" C | PROVIDE ABB VFD | N/A | N/A | 30A | PROVIDE NEW WIRING, DISCONNECT, CONTROLLER AND SQUARE D OVERCURRENT PROTECTION IN MCC 41. |

FIRE ALARM

HEAT DETECTOR, ADDRESSABLE

O BASE HEAT DETECTOR, ADDRESSABLE

SMOKE DETECTOR, ADDRESSABLE

SMOKE DETECTOR, ADDRESSABLE, DUCT TYPE, MECHANICAL UNIT INDICATED

SMOKE DETECTOR ALSO FOR SMOKE DAMPER OPERATION, ADDRESSABLE

CO CO BASED SMOKE DETECTOR, ADDRESSABLE


HET FIRE ALARM STROBE UNIT, WALL MOUNTED STROBE CANDELA INDICATED

COMBINATION FIRE ALARM HORN/STROBE UNIT, STROBE CANDELA INDICATED


FSR FAN SHUTDOWN RELAY


SD FIRE SMOKE DAMPER RELAY

| DESIGN BASE: SQUARE D OR APPROVED EQUAL LOCATION: LOADING DOCK RATING: Amps MAIN: 225 Amp MLO | | PANEL SCHEDULE LP1E | | | | S.C. RATING: 14,000 Amps RN SERVICE: 277/480V, 3Ø, 4W MOUNTING: SURFACE FEED: EXISTING | MS SYM. | | | | | |
|--|---------------------|---------------------------|--------------|--------------|--------------|---|-------------|----------------|--------------|------------|---------------------|------|
| CKT. | LOAD DESIGNATION | LOAD (kVA) | WIRE SIZE | BRE/ TRIP | AKER POLE | PHASE A B C | BRE POLE | AKER TRIP | WIRE SIZE | LOAD (kVA) | LOAD DESIGNATION | СКТ. |
| 1 | | | | | - | • | | | | | SPACE | 2 |
| 3 | EXISTING LOAD | | | | - | | - | | | | SPACE | 4 |
| 5 | | | | | - | + + + | + | | | | SPACE | 6 |
| 7 | EXISTING LOAD | | | | - | • | + | | | | EXISTING LOAD | 8 |
| 9 | EXISTING LOAD | | | | - | | + | | | | EXISTING LOAD | 10 |
| 11 | SPACE | | | | - | • | - | | | | EXISTING LOAD | 12 |
| 13 | SPACE | | | | - | • | + | | | | EXISTING LOAD | 14 |
| 15 | EXISTING LOAD | | | | \sim | | + | | | | EXISTING LOAD | 16 |
| 17 | EXISTING LOAD | | | | - | + + + | + | | | | EXISTING LOAD | 18 |
| 19 | EXISTING LOAD | | | | - | • | - | | | | EXISTING LOAD | 20 |
| 21 | SPACE | | | | \sim | | + | | | | EXISTING LOAD | 22 |
| 23 | SPACE | | | | - | • | - | | | | EXISTING LOAD | 24 |
| 25 | EXISTING LOAD | | | | - | • | - | | | | SPACE | 26 |
| 27 | EXISTING LOAD | | | | - | | - | | | | EXISTING LOAD | 28 |
| 29 | EXISTING LOAD | | | | - | • | - | | | | EXISTING LOAD | 30 |
| 31 | EXISTING LOAD | | | | <u> </u> | • • | - | | | | EXISTING LOAD | 32 |
| 33 | SPACE | | | | - | • • • | - | | | | EXISTING LOAD | 34 |
| 35 | SPACE | | | | | | | | | | SPACE | 36 |
| 37 | | | #10AWG | | <u> </u> | | | | #10 AWG | | | 38 |
| 39 | WEST P LOT LTG | | #10AWG | 20 | | | | 20 | #10 AWG | | EAST PLOT | 40 |
| 41 | | | #10AWG | | | | | | #10 AWG | | | 42 |

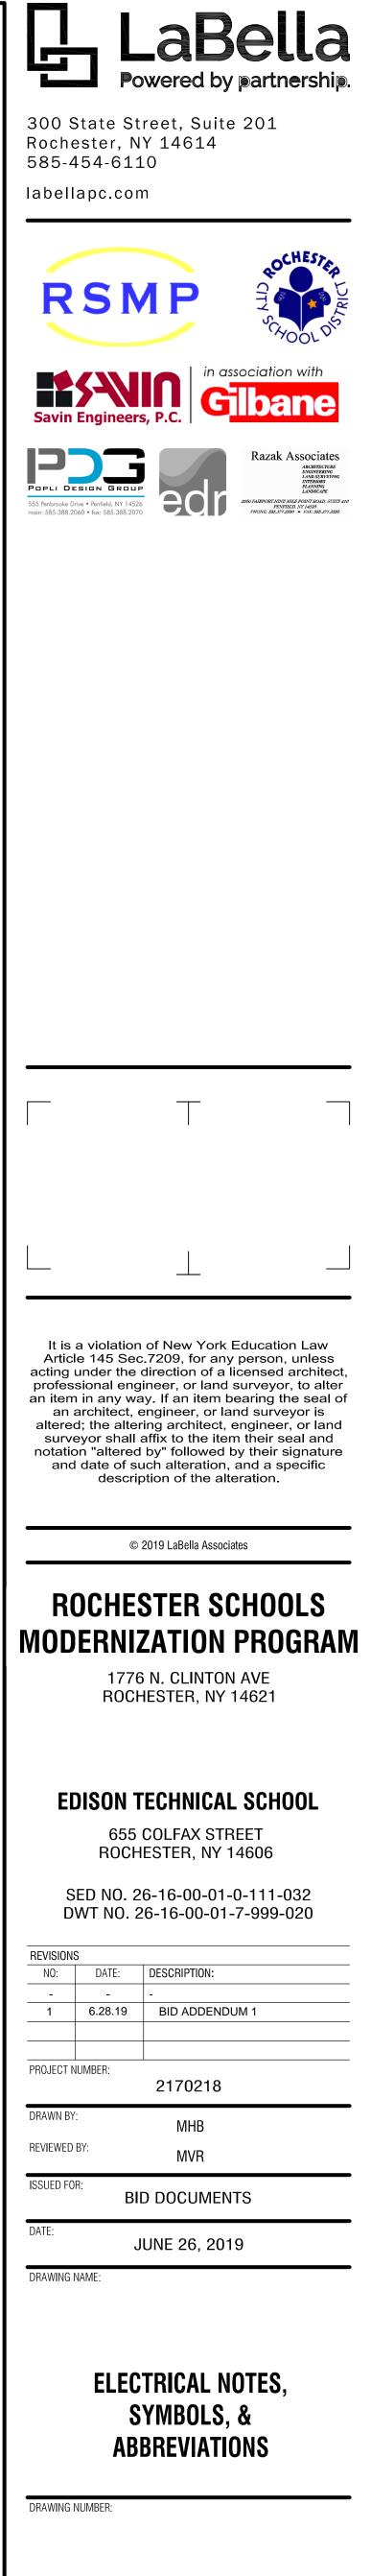

E000

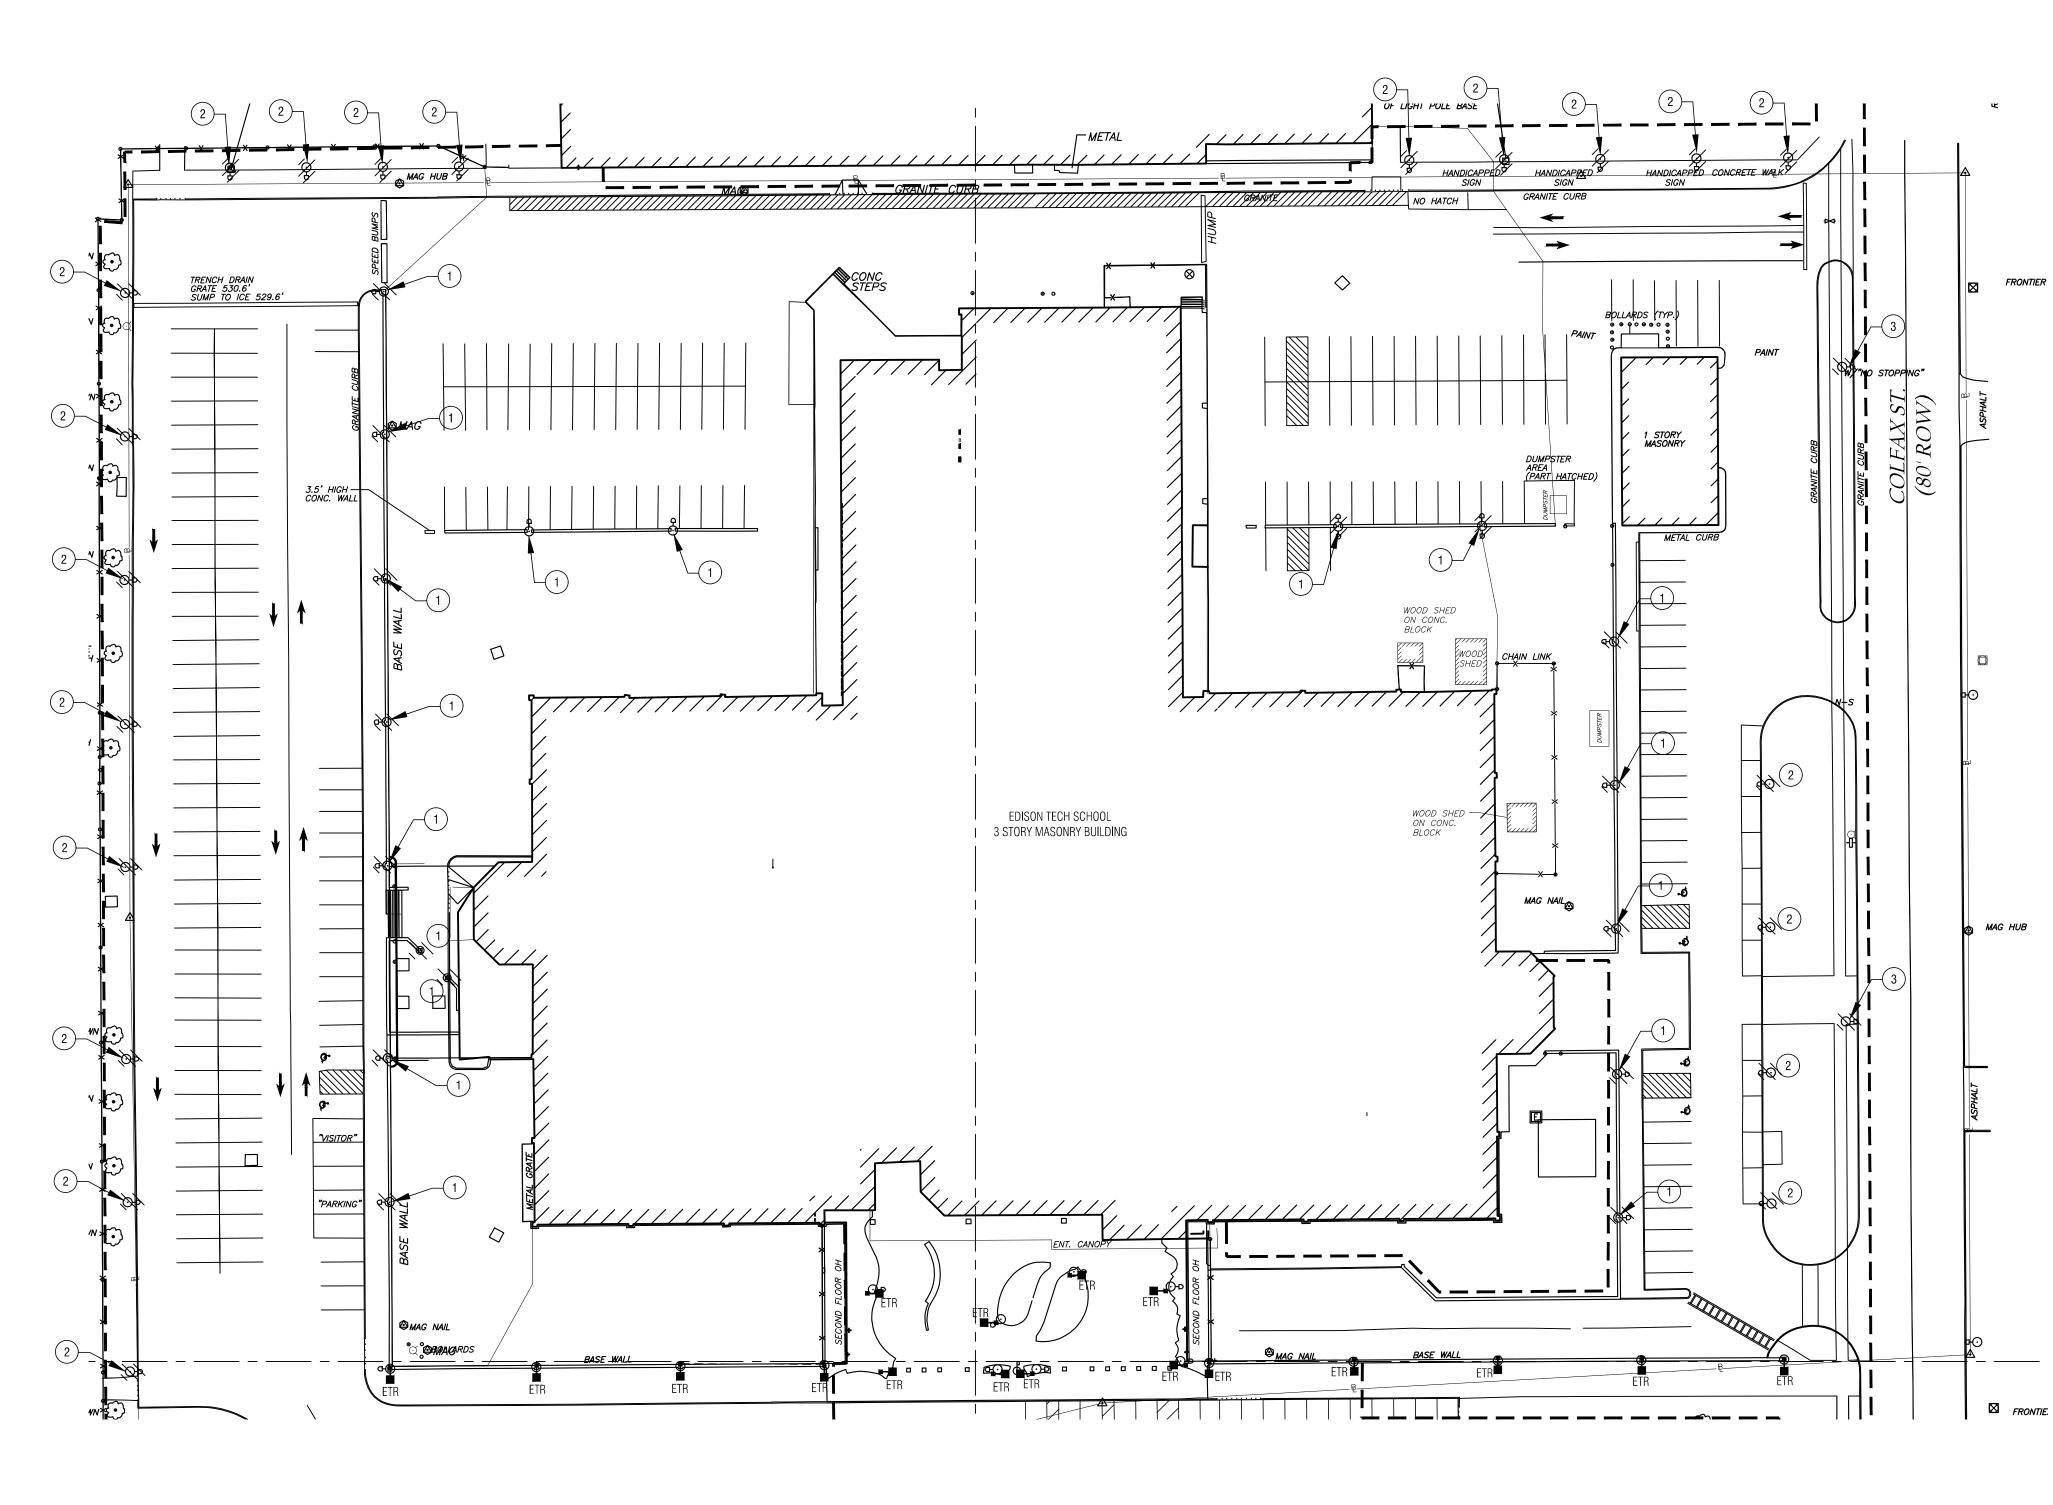

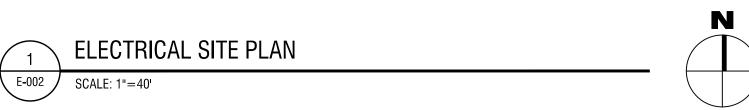

LEGEND:

----- UNDERGROUND OR SURFACE CONDUIT

- E ELECTRICAL HAND HOLE
- JUNCTION BOX
- NEW LIGHT POLE
- ♀ EXISTING LIGHT POLE
- SURFACE MOUNT PANELBOARD
- AWG AMERICAN WIRE GAUGE CKT CIRCUIT
- ETR EXISTING TO REMAIN GND GROUND

FRONTIER

ELECTRIC GENERAL NOTES:


- 1. WHERE FIXTURES ARE INDICATED TO BE REMOVED, THEY AND THEIR RELATED WIRING/CONDUIT SHALL BE REMOVED BACK TO THE SOURCE PANEL BOARD. IF CIRCUITS ARE FOUND TO HAVE OTHER LOADS ON THEM THAT ARE TO REMAIN, THESE CIRCUIT SHALL REMAIN. MAINTAIN CIRCUIT CONTINUITY TO FEED THRU TO ANY REMAINING LOADS. PROPERLY TERMINATE ALL WIRING.
- 2. FIELD VERIFY EXISTING CIRCUITING WITH OWNER.
- 3. PROVIDE SCHEDULE 40 PVC FOR UNDERGROUND CONDUITS. TRANSITION TO GALVANIZED STEEL RMC AT EXTERIOR WALL PENETRATIONS.
- 4. EXISTING CONDUITS MAY BE REUSED WHERE POSSIBLE.
- 5. UNDERGROUND CONDUITS SHALL BE A MINIMUM OF 30" BELOW FINISH GRADE.
- 6. TRANSFER TO ABOVE GRADE WITH GALVANIZED STEEL RMC PRIOR TO PENETRATING THE BUILDING.
- 7. VISIT THE SITE TO DETERMINE THE EXACT EXTENT OF ELECTRICAL DEMOLITION WORK REQUIRED TO COMPLETE THE NEW CONSTRUCTION. EXISTING CONDITIONS ARE TAKEN FROM FIELD OBSERVATION AND EXISTING BUILDING CONSTRUCTION DOCUMENTS. OTHER ITEMS MAY EXIST.
- 8. ALL LIGHTING CIRCUITS ARE TO BE MAINTAINED FOR REUSE. 9. PROVIDE NEW PANEL LOAD SCHEDULES FOR ALL PANELS, BOTH EXISTING AND NEW. ALL EXISTING LOADS SHALL BE TRACED AND

CONFIRMED IN THE FIELD.


10. PAINT PULL BOXES TO MATCH WALL AND CEILINGS IF LOCATED IN FINISHED AREA, EXPOSED TO VIEW.

ELECTRIC GENERAL DEMOLITION NOTES:

- 1 REMOVE POLE, FIXTURE HEAD AND WIRING BACK TO SOURCE, EXISTING CONCRETE BASE TO BE REUSED IF BASE BOLTS ARE FOUND IN GOOD CONDITION AFTER COVER REMOVAL AND INSPECTION. EXISTING WALL MOUNT CONDUIT TO BE REUSED FOR NEW CONDUIT.
- (2) REMOVE LIGHT POLE, CONCRETE BASE, FIXTURE HEAD, CONDUIT AND WIRING BACK TO SOURCE.
- 3 DISCONNECT AND REMOVE STREET LIGHT POLES. COORDINATE WITCH CITY OF ROCHESTER AND RGE.

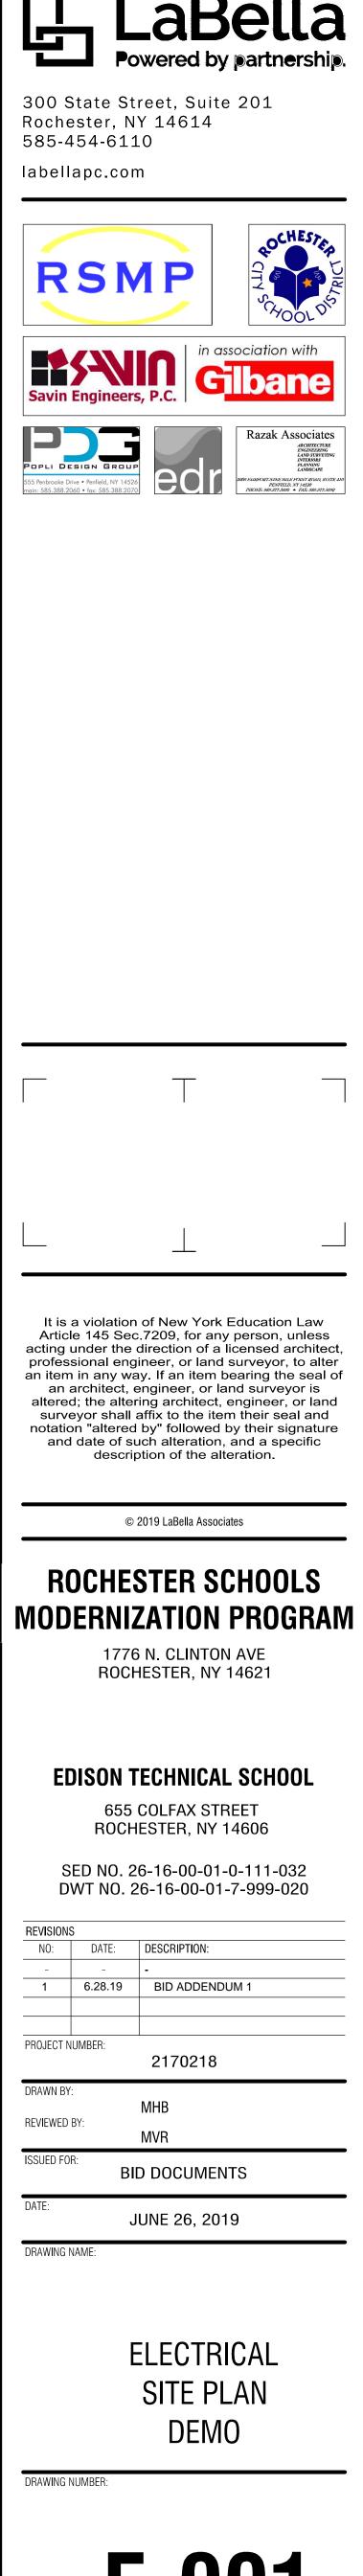

E-001

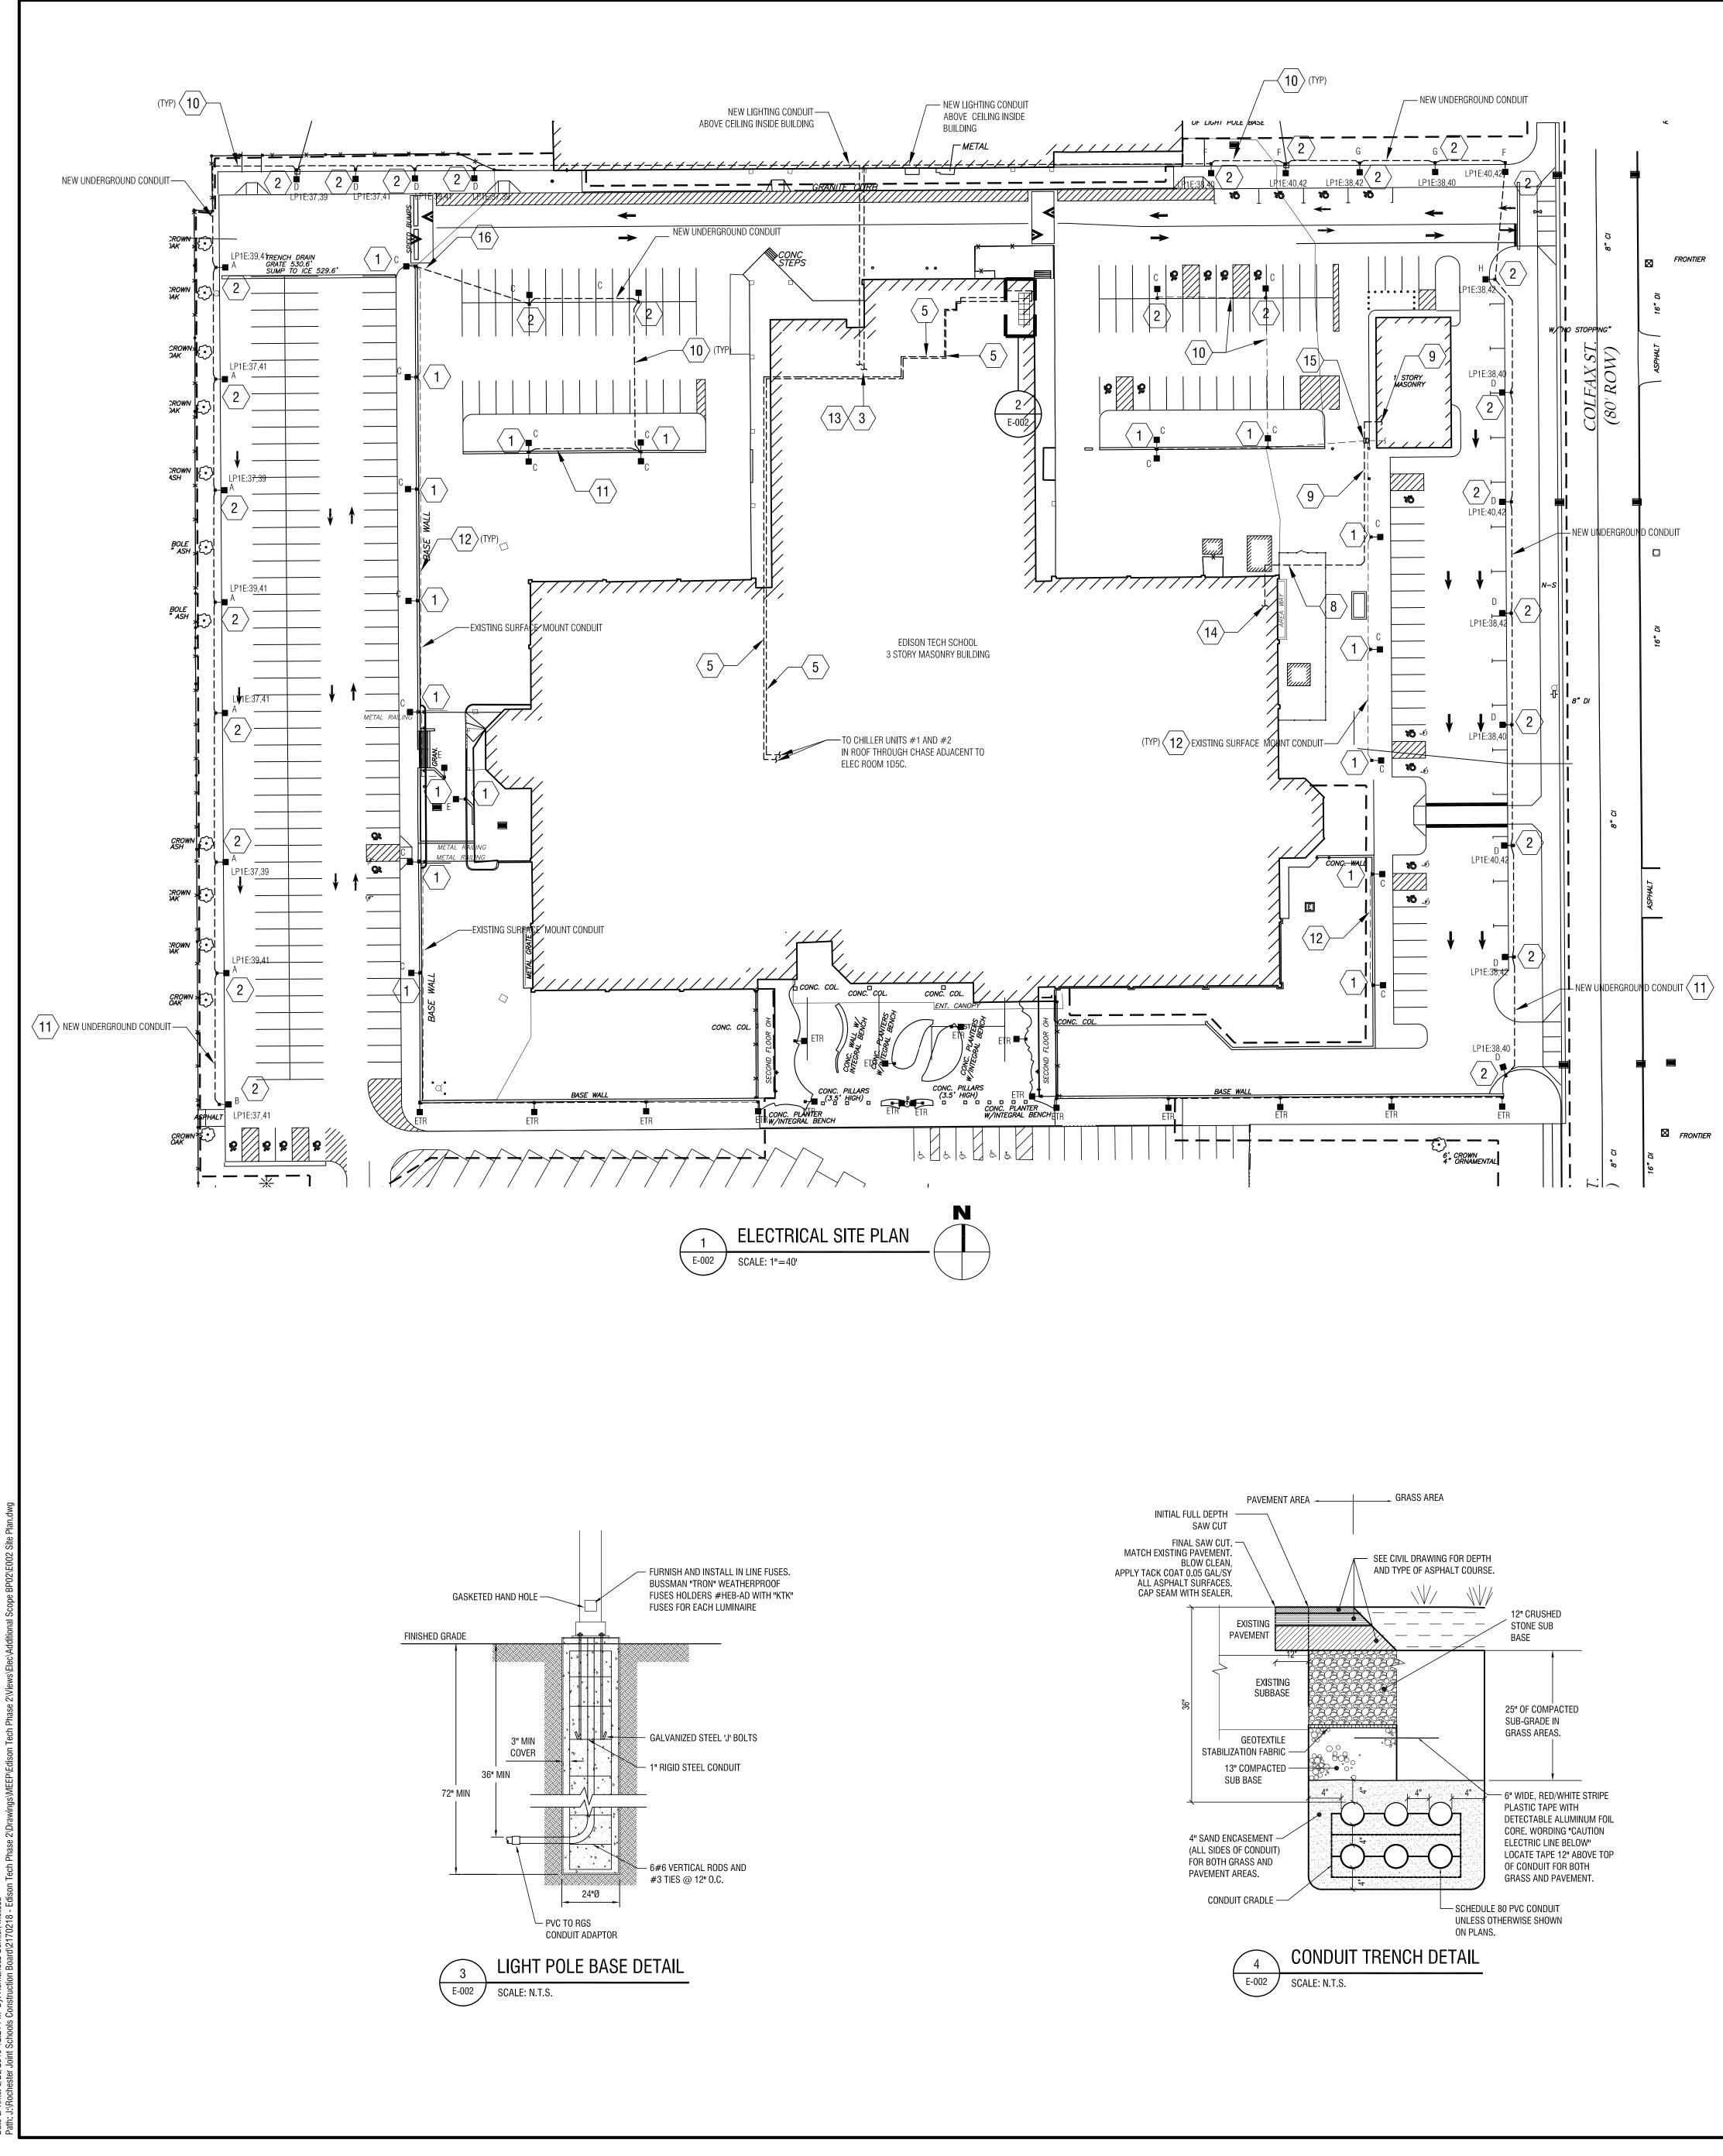

LEGEND:

- ----- UNDERGROUND OR SURFACE
- CONDUIT E ELECTRICAL HAND HOLE
- JUNCTION BOX
- NEW LIGHT POLE
- ♀ EXISTING LIGHT POLE SURFACE MOUNT PANELBOARD
- AWG AMERICAN WIRE GAUGE
- CKT CIRCUIT ETR EXISTING TO REMAIN
- GND GROUND


ELECTRIC GENERAL NOTES:


- WHERE FIXTURES ARE INDICATED TO BE REMOVED, THEY AND THEIR RELATED WIRING/CONDUIT SHALL BE REMOVED BACK TO THE SOURCE PANEL BOARD. IF CIRCUITS ARE FOUND TO HAVE OTHER LOADS ON THEM THAT ARE TO REMAIN, THESE CIRCUIT SHALL REMAIN. MAINTAIN CIRCUIT CONTINUITY TO FEED THRU TO ANY REMAINING LOADS. PROPERLY TERMINATE ALL WIRING.
- 2. FIELD VERIFY EXISTING CIRCUITING WITH OWNER.
- 3. PROVIDE SCHEDULE 40 PVC FOR UNDERGROUND CONDUITS. TRANSITION TO GALVANIZED STEEL RMC AT EXTERIOR WALL PENETRATIONS.
- 4. EXISTING CONDUITS MAY BE REUSED WHERE POSSIBLE.
- 5. UNDERGROUND CONDUITS SHALL BE A MINIMUM OF 30" BELOW FINISH GRADE.
- 6. TRANSFER TO ABOVE GRADE WITH GALVANIZED STEEL RMC PRIOR TO PENETRATING THE BUILDING.
- 7. VISIT THE SITE TO DETERMINE THE EXACT EXTENT OF ELECTRICAL DEMOLITION WORK REQUIRED TO COMPLETE THE NEW CONSTRUCTION. EXISTING CONDITIONS ARE TAKEN FROM FIELD OBSERVATION AND EXISTING BUILDING CONSTRUCTION DOCUMENTS. OTHER ITEMS MAY EXIST.
- 8. ALL LIGHTING CIRCUITS ARE TO BE MAINTAINED FOR REUSE. 9. PROVIDE NEW PANEL LOAD SCHEDULES FOR ALL PANELS, BOTH
- EXISTING AND NEW. ALL EXISTING LOADS SHALL BE TRACED AND CONFIRMED IN THE FIELD.
- 10. PAINT PULL BOXES TO MATCH WALL AND CEILINGS IF LOCATED IN FINISHED AREA, EXPOSED TO VIEW.


ELECTRICAL KEYED NOTES:

| $\langle 1 \rangle$ | PROVIDE LIGHT POLE, WITH LED HEAD FIXTURE AND INTEGRAL PHOTOCELL PROVIDE ONLY (1) PHOTOCELL PER LIGHTING CIRCUIT. |
|----------------------|--|
| $\langle 2 \rangle$ | PROVIDE LIGHT POLE, BASE AND LED HEAD FIXTURE AND INTEGRAL PHOTOCELL. PROVIDE ONLY (1) PHOTOCELL PER LIGHTING CIRCUIT. |
| $\langle 3 \rangle$ | PROVIDE NEW CIRCUITS ABOVE CEILING FROM AVAILABLE SPACES OR SPA IN PANEL LP-1E IN LOADING DOCK FOR SITE LIGHTING. CIRCUIT ROUTE MU GO UP ABOVE 2ND FLOOR CEILING AND DOWN ON THE GYM BUILDING SID |
| 4 | PROVIDE NEW 1200A SIEMENS SWITCH, 480V, 3PH FOR NEW CHILLER UNI REMOVE EXISTING VERTICAL BUS IN SECTION AND REPLACE WITH (2) 3/16 INCHES THICK BY 4 INCHES WIDE NEW ALUMINUM BUS BARS FOR A 1200/ BUS BAR RATING PER PHASE. BUS BAR WORK MUST BE PERFORMED BY A SIEMENS CERTIFIED PERSONNEL. |
| 5 | CHILLER FEEDERS EXPOSED THROUGH BASEMENT: (3) SETS OF 500KCMIL AND (1) 3/0 GND IN 4" CONDUIT. |
| $\langle 6 \rangle$ | NOT USED. |
| $\langle 7 \rangle$ | EXISTING LIGHTING CIRCUIT TO REMAIN. |
| $\langle 8 \rangle$ | NEW SPARE CONDUIT FOR FUTURE STORAGE BUILDING FIRE ALARM UPGRA |
| 9 | NEW STORAGE BUILDING FIRE ALARM WALL MOUNT SPARE CONDUIT.TERMINATE CONDUIT INSIDE BUILDING WITH A JUNCTION BOX. |
| $\langle 10 \rangle$ | (3)#10 AWG WIRES AND (1)#10 GND IN 1" CONDUIT. |
| $\langle 11 \rangle$ | (2)#10 AWG WIRES AND (1)#10 GND IN 1" CONDUIT. |
| (12) | (3)#10 AWG WIRES AND (1)#10 GND IN EXISTING CONDUIT. REUSE EXIST CIRCUITING. |
| (13) | PROVIDE SURFACE MOUNT LIGHTING PANELBOARD. |
| $\langle 14 \rangle$ | PROVIDE NEW JBOX TO TIE IN NEW SPARE CONDUIT FOR STORAGE BUILDIN FIRE ALARM SYSTEM TO ROOM 1C3 EXISTING FIRE ALARM CONDUIT. |
| (15) | PROVIDE NEW ELECTRICAL HANDHOLE AND EXTEND EXISTING LIGHTING CIRCUITING TO PARKING LOT LIGHTING. |

 $\langle 16
angle$ extend existing circuiting to parking lot lighting.

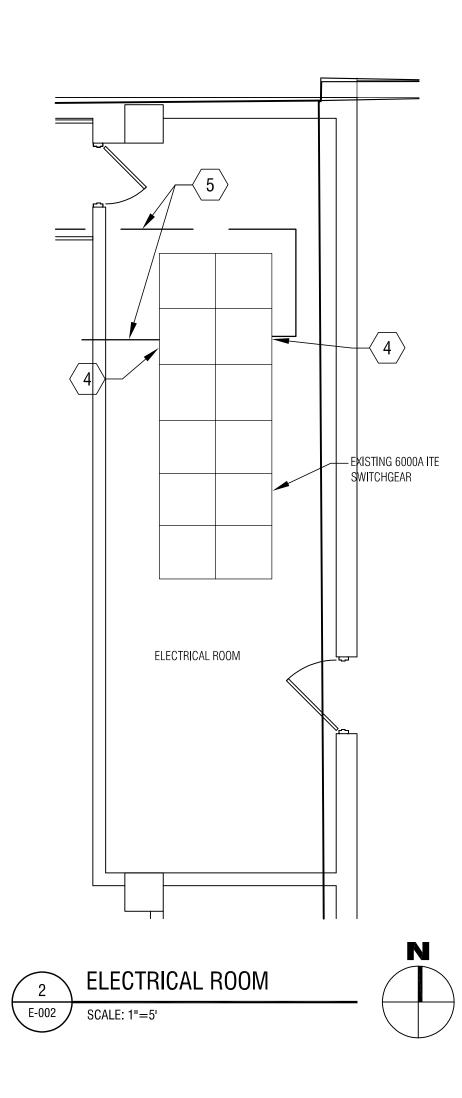

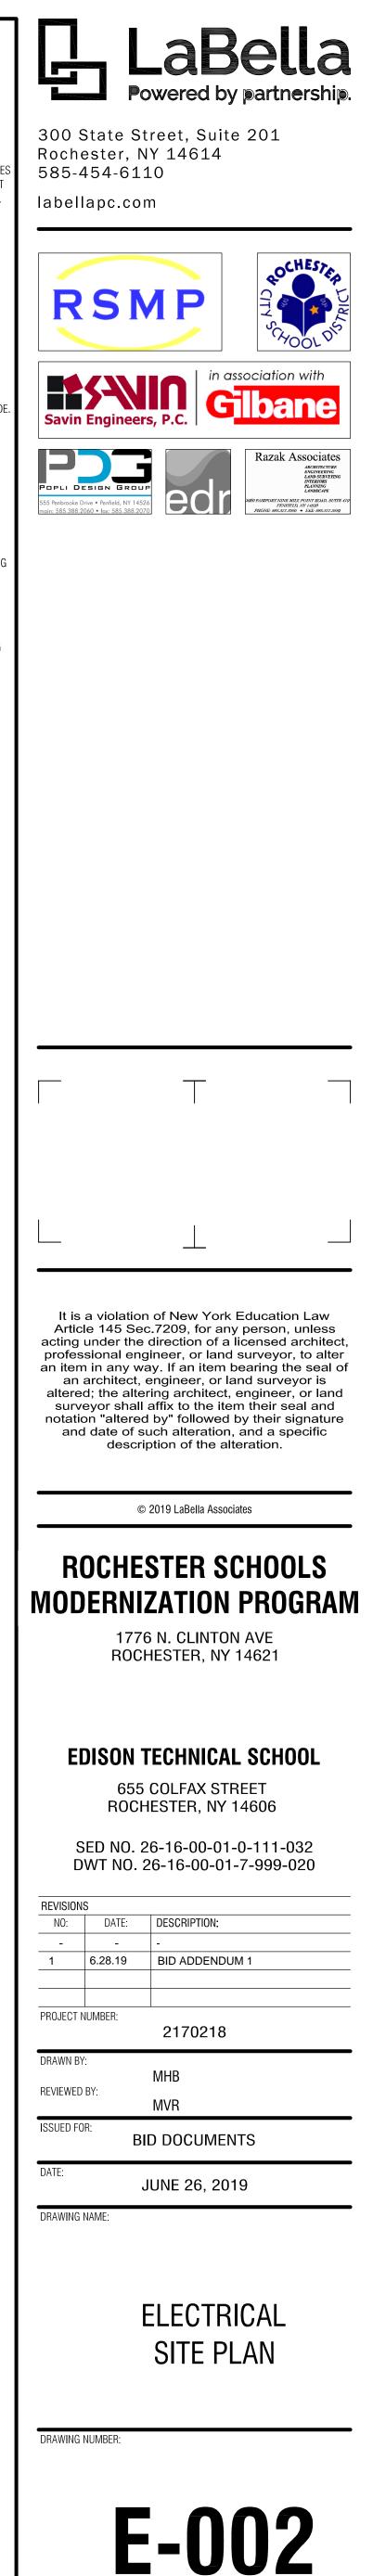

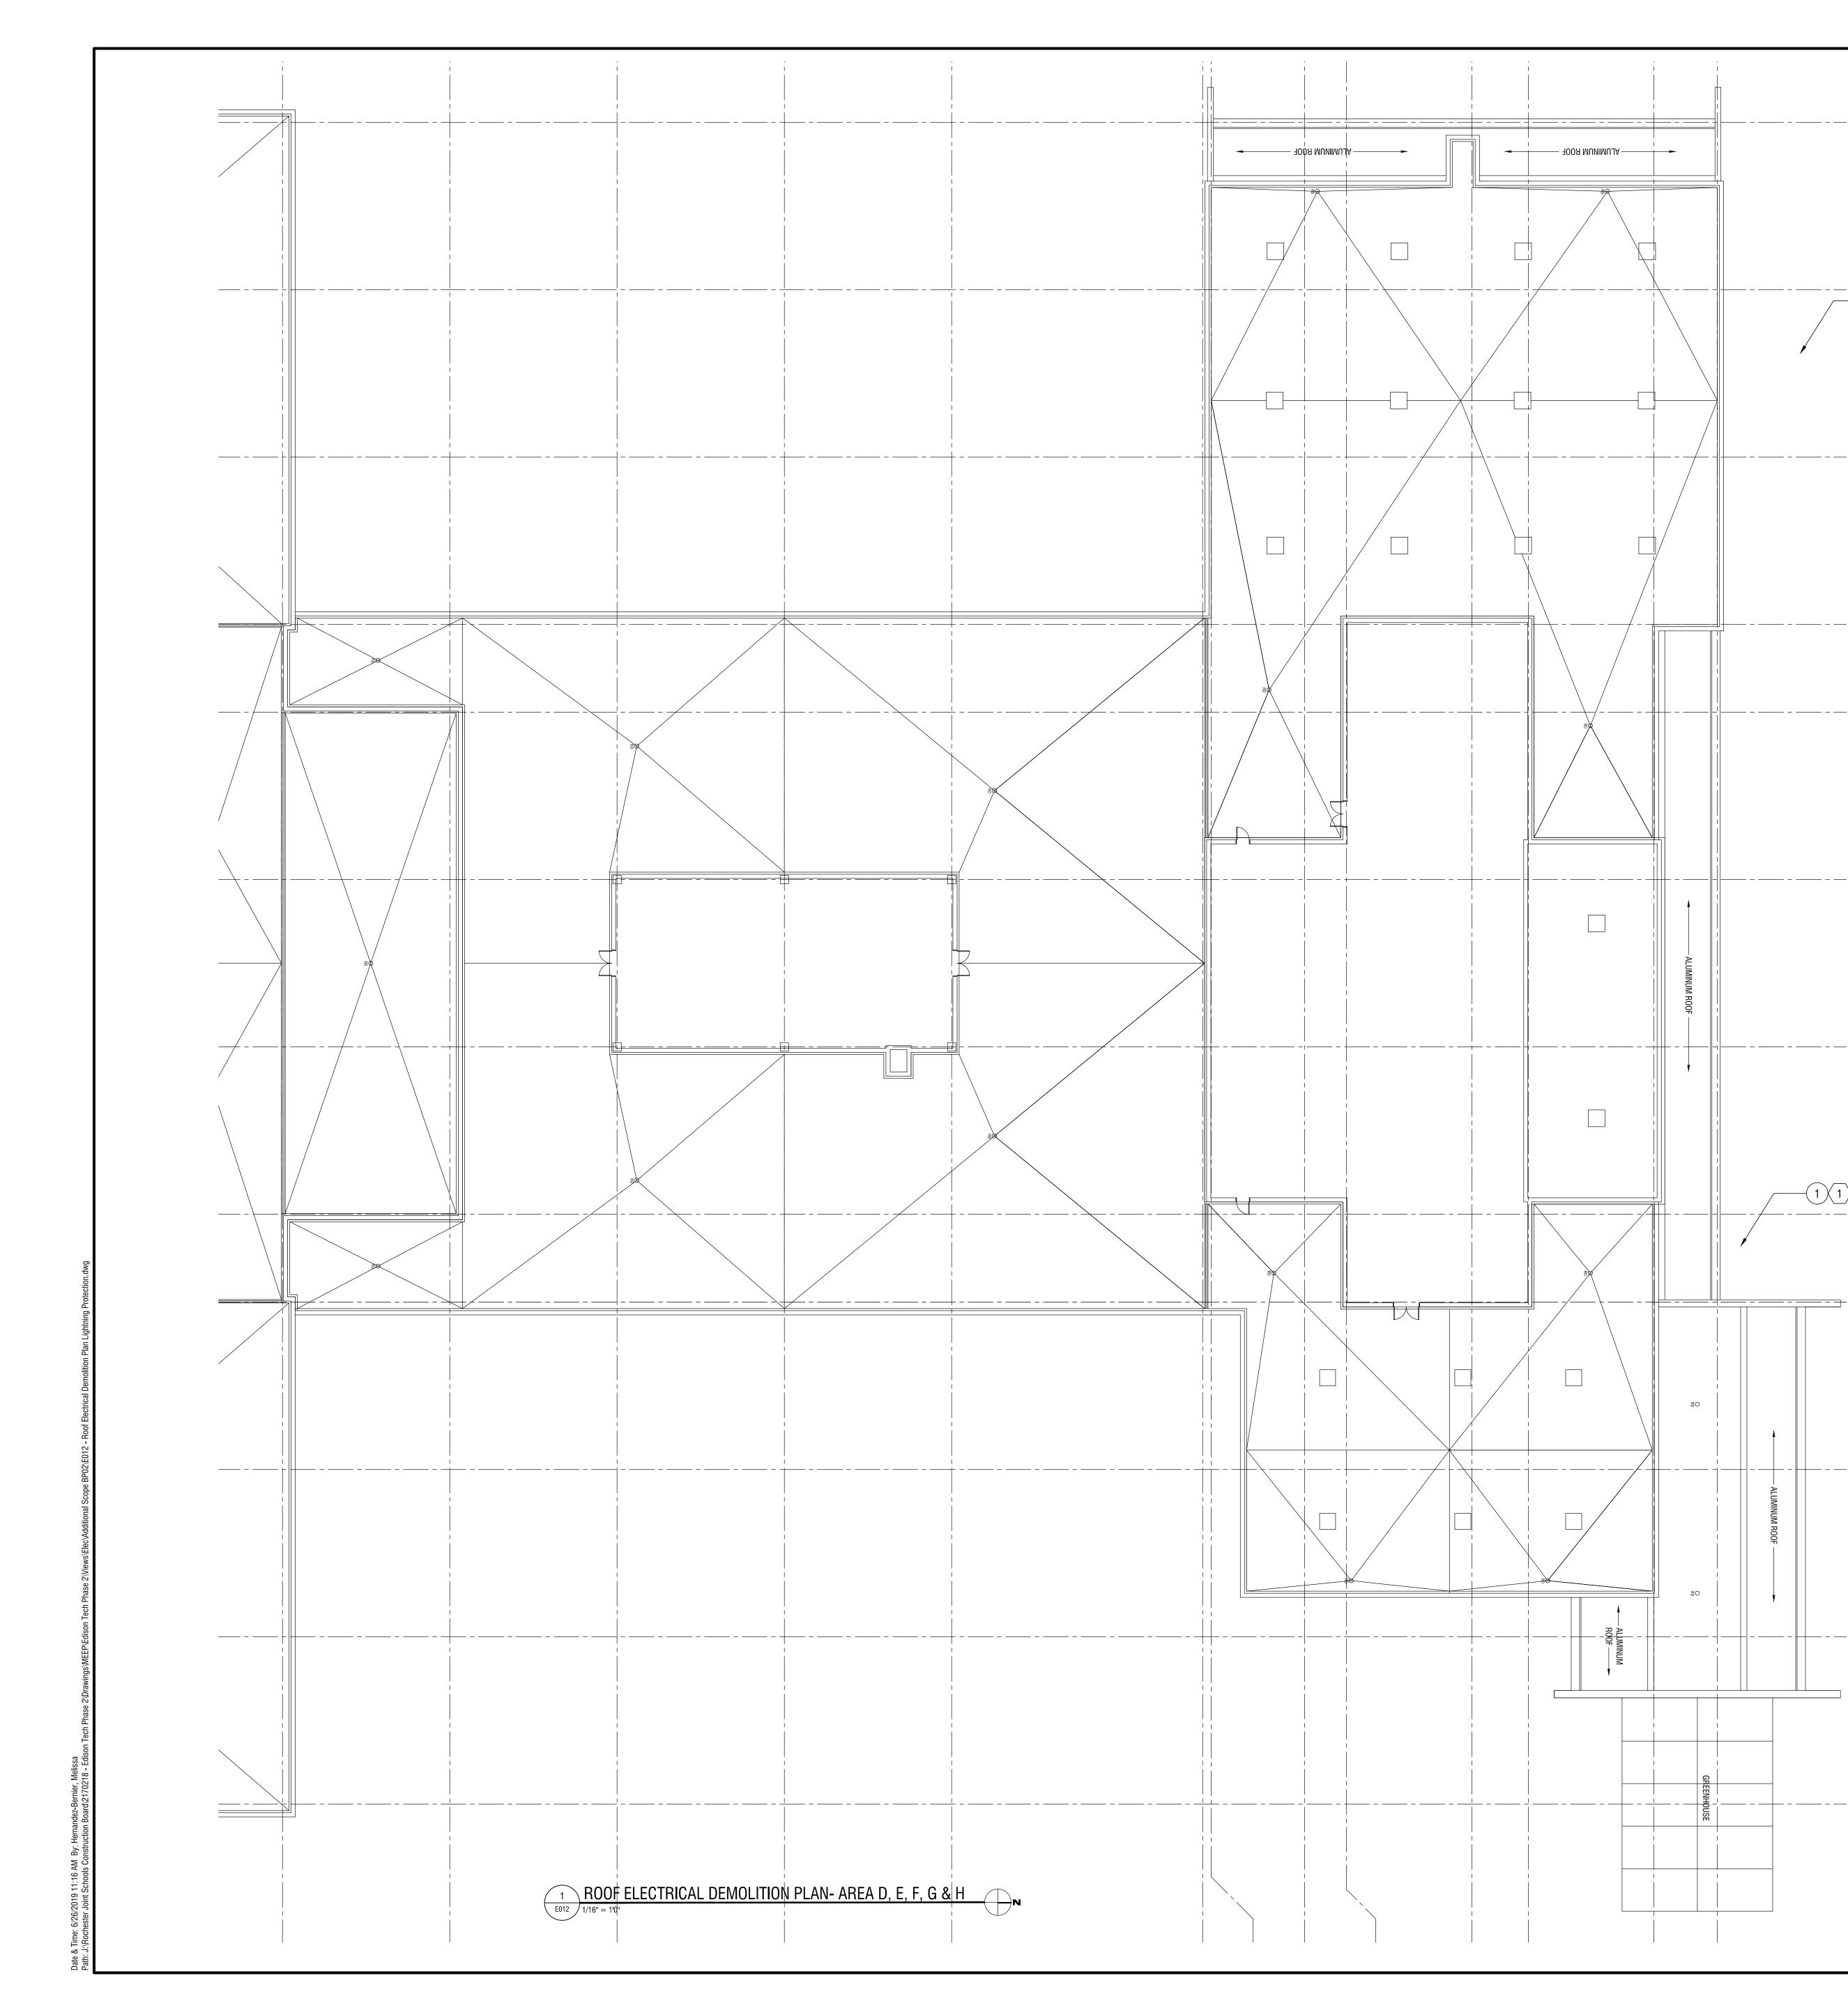

GENERAL LIGHTNING PROTECTION NOTES

- 1. THE LIGHTNING PROTECTION SYSTEM SHALL BE INSTALLED IN ACCORDANCE WITH U.L. 96A. NFPA 780 AND ANSI CODE REQUIREMENTS.
- 2. CONDUCTORS SHALL MAINTAIN A HORIZONTAL OR DOWNWARD COURSE, FREE FROM "U" OR "V" (UP AND DOWN) POCKETS.
- 3. NO BEND OF A CONDUCTOR SHALL HAVE A BEND RADIUS OF LESS THAN 8 INCHES.
- 4. ACTUAL JOB SITE CONDITIONS SHALL REQUIRE SLIGHT ALTERATIONS IN AIR TERMINAL AND GROUND ROD LOCATIONS.
- 5. BARE COPPER MATERIALS SHALL NOT BE INSTALLED ON ALUMINUM SURFACE AND ALUMINUM MATERIALS SHALL NOT BE INSTALLED ON COPPER SURFACE. ALUMINUM COMPONENTS SHALL NOT BE IN DIRECT CONTACT WITH EARTH. ALUMINUM DOWN CONDUCTORS SHALL BE CONNECTED TO COPPER CONDUCTORS USING BIMETALLIC FITTINGS WITHIN 18 INCHES OF EARTH.
- THE LIGHTNING PROTECTION SYSTEM SHALL BE INSTALLED IN A NEAT WORKMANLIKE AND INCONSPICUOUS MANNER SO THAT ALL COMPONENTS WILL BLEND IN WITH BUILDING AESTHETICS.
- 7. ALL ADHESIVE AIR TERMINALS BASES AND FITTINGS SHALL BE SECURED TO ROOF WITH AN ADHESIVE COMPOUND OR PITCH WHICH COMPLIES WITH ROOFING BOND REQUIREMENTS. ATTACHMENT OF CABLE SECURED TO AIR TERMINALS, AND BUILDING SHALL BE SECURED ALONG THE CABLE RUN AND ATTACHMENTS AND SHALL NOT BE MORE THAN 3 FT APART.
- 8. EACH INDIVIDUAL ITEM OF THE LIGHTNING PROTECTION SYSTEM IS NOT LABELED FOR SAKE OF CLARITY. ITEMS ARE INDICATED AT RANDOM LOCATIONS ONLY. PROVIDE A COMPLETE SYSTEM THAT SHALL INCLUDE A UL "MASTER LABEL" CERTIFICATION.
- 9. CONDUCTOR SUPPORTS SHALL BE CORROSION RESISTANT TYPE.
- 10. WHERE TERMINALS GREATER THAN 24 INCHES IN HEIGHT ARE USED, THEY SHALL BE SUPPORTED AT A POINT AT LEAST HALF THE HEIGHT OF THE ROD AND BE SPACED MORE THAN 20 BUT NOT LESS THAN 25 FEET APART FOR PERIMETER PROTECTION.
- 11. METAL BODIES WITHIN 6'-0" OF THE LIGHTNING PROTECTION SYSTEM SHALL BE BONDED TO THE SYSTEM IN ACCORDANCE WITH UL96A.
- 12. ALL LIGHTNING PROTECTION SYSTEM COMPONENTS SHALL BE LISTED, EXCEPTING HARDWARE SCREWS, BOLTS, ETC.
- 13. MAIN SIZE CONDUCTORS USED FOR BONDING OTHER SYSTEMS TO INCLUDE BUT NOT LIMITED TO: METALLIC WATER SYSTEMS, STEAM OR HOT WATER HEATING SYSTEMS, ELECTRIC SERVICES, TELEPHONE SYSTEMS, ANTENNA GROUNDS, OTHER LARGE UNGROUNDED METALLIC MASSES SHALL NOT BE SMALLER THAN 6 AWG.


DEMOLITION NOTES

(1) DISCONNECT AND REMOVE LIGHTNING PROTECTION WIRING LAID ON GROUND WITH CARE FOR ROOF WORK. STORE IN A SECURE LOCATION AND PROTECT FROM DEMOLITION WORK.

KEY NOTES

-1

 $\langle 1 \rangle$ Install lightning protection wiring as indicated on roof plan.

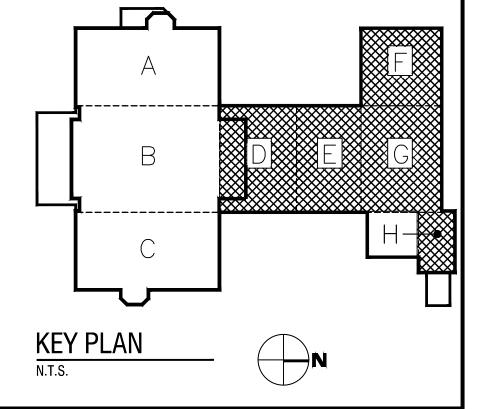





| T | |
|---|--|
| | |
| | |

It is a violation of New York Education Law Article 145 Sec.7209, for any person, unless acting under the direction of a licensed architect, professional engineer, or land surveyor, to alter an item in any way. If an item bearing the seal of an architect, engineer, or land surveyor is altered; the altering architect, engineer, or land surveyor shall affix to the item their seal and notation "altered by" followed by their signature and date of such alteration, and a specific description of the alteration

© 2019 LaBella Associates

ROCHESTER SCHOOLS MODERNIZATION PROGRAM 1776 N. CLINTON AVE ROCHESTER, NY 14621

EDISON TECHNICAL SCHOOL 655 COLFAX STREET

ROCHESTER, NY 14606


SED NO. 26-16-00-01-0-111-032

| DWT NO. 26-16-00-01-7-999-020 | | | | | | | |
|-------------------------------|-----------|----------------|--|--|--|--|--|
| REVISION | REVISIONS | | | | | | |
| NO: | DATE: | DESCRIPTION: | | | | | |
| _ | - | - | | | | | |
| 1 | 6.28.19 | BID ADDENDUM 1 | | | | | |
| | | | | | | | |
| | | | | | | | |
| PROJECT N | IUMBER: | | | | | | |
| | | 2170218 | | | | | |
| DRAWN BY: VP | | | | | | | |
| REVIEWED | BY: | MVR | | | | | |
| ISSUED FOR: BID DOCUMENTS | | | | | | | |
| DATE: JUNE 26, 2019 | | | | | | | |
| | | | | | | | |

DRAWING NAME:

ROOF ELECTRICAL **DEMOLITION PLAN-**LIGHTNING PROTECTION AREA D, E, F, G, & H



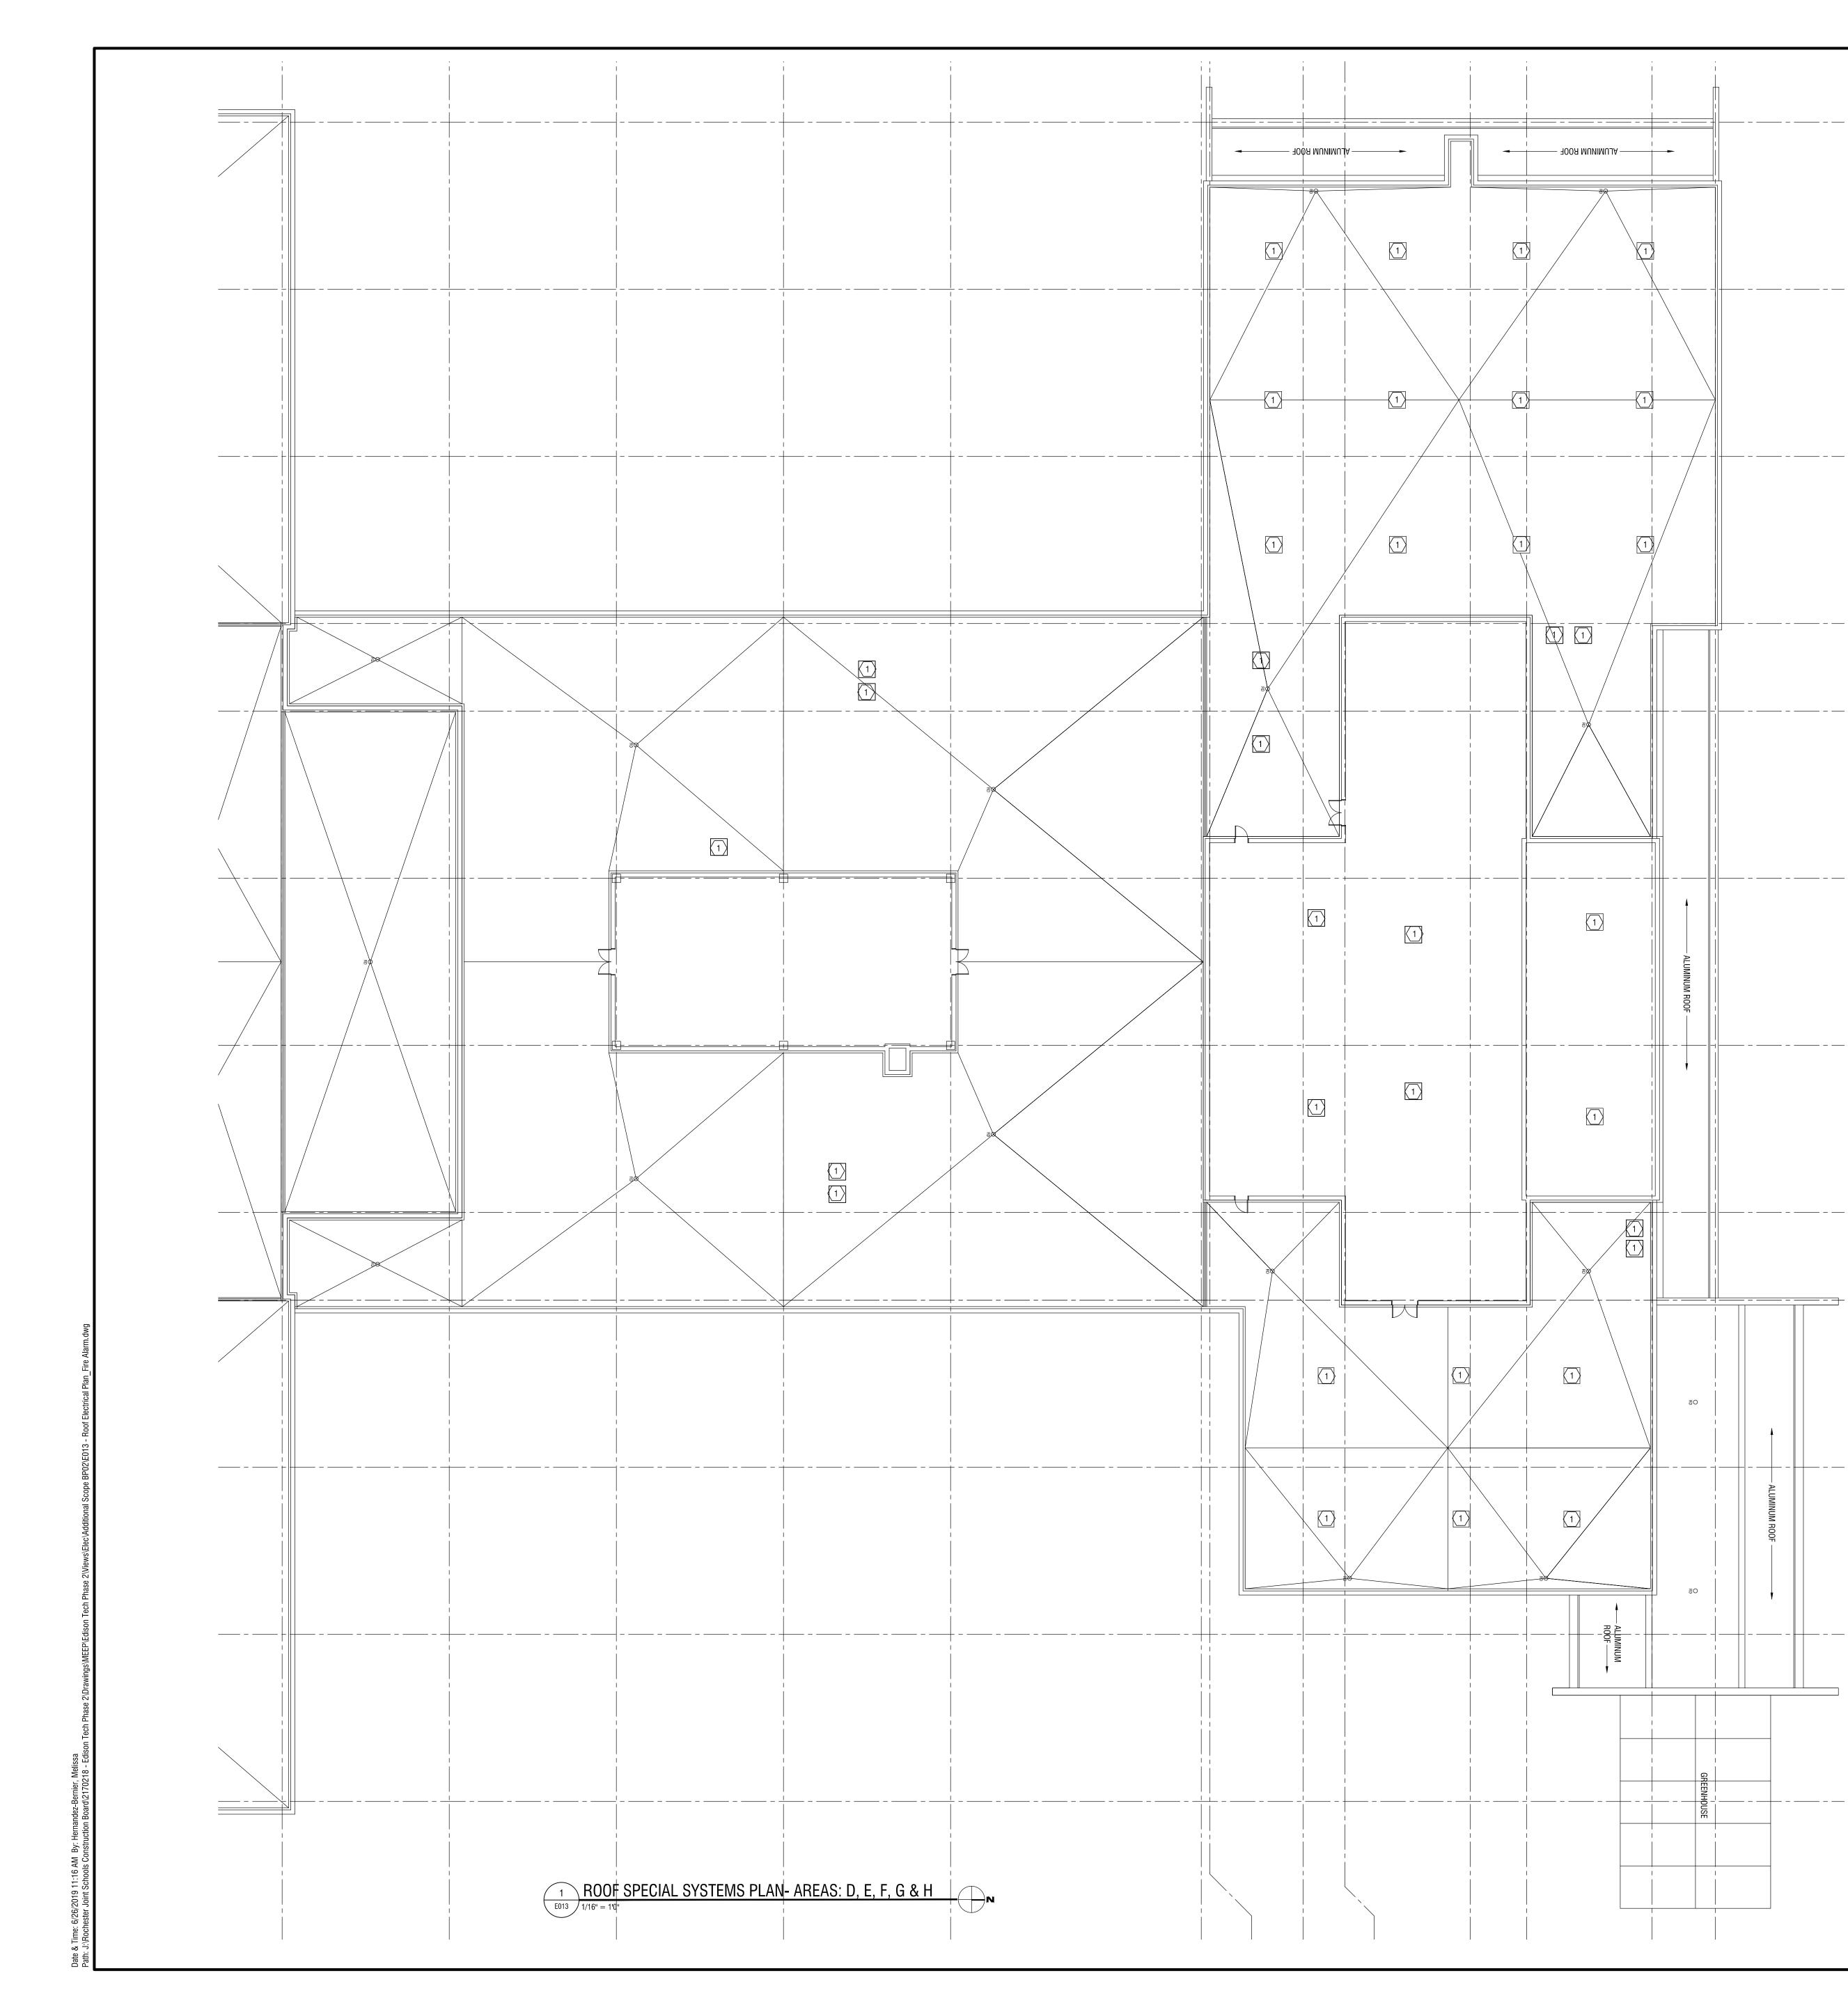


ELECTRIC GENERAL NOTES:

- A ELECTRICAL CONTRACTOR SHALL COORDINATE ALL ELECTRICAL DEVICE PLACEMENT AND ELEVATIONS WITH CASEWORK SUPPLIER AND ARCHITECTS PRIOR TO ROUGH-IN. GENERAL CONTRACTOR SHALL PROVIDE ALL DRILLING AND GROMMETING IN CASEWORK FOR CORD ACCESS IF REQUIRED.
- B COORDINATE LOCATIONS OF CEILING DEVICES IN MECHANICAL SPACES WITH HVAC CONTRACTOR TO AVOID CONFLICTS WITH EQUIPMENT.
- C PROVIDE NEW WIRING FOR ALL NEW ADDRESSABLE FIRE ALARM SYSTEM DEVICES.
- D WHERE DOOR HOLDERS ARE SHOWN, IF EXISTING DOOR HARDWARE IS TO REMAIN PROVIDE A POWER SUPPLY WITH A 24V WIRING.
- E POWER TO SMOKE DAMPER ACTUATORS MUST BE THRU A FIRE SYSTEM RELAY. RELAY TO BE MOUNT ADJACENT TO DAMPER. UPON NEAREST UPSTREAM SD SMOKE DETECTOR ACTIVATION, RELAY SENDS ACTUATOR SIGNAL TO CLOSE DAMPER. REFER TO MECHANICAL PLANS FOR FIRE SMOKE DAMPER LOCATIONS.

ELECTRIC KEYED NOTES:

1 DISCONNECT EXISTING SMOKE DETECTOR AT SMOKE HATCH AND REUSE EXISTING CIRCUITING IF IT'S AN EMERGENCY CIRCUIT. IF ON NORMAL POWER, REMOVE WIRING BACK TO SOURCE, LABEL BRANCH BREAKER AS AVAILABLE AND PROVIDE NEW 120V, 20A EMERGENCY CIRCUIT FROM NEAREST PANEL. PROVIDE A NEW ADDRESSABLE 120V SMOKE DETECTOR. AND CONNECT TO BUILDING FIRE ALARM PANEL THROUGH 24V LINE FOR SMOKE DETECTOR STATUS MONITORING AND TO ELECTRIC THERMOLATCH.

NEW EMERGENCY CIRCUITS FROM AVAILABLE SPACES AVAILABLE IN PANEL EP2G IN ROOM 2G15.

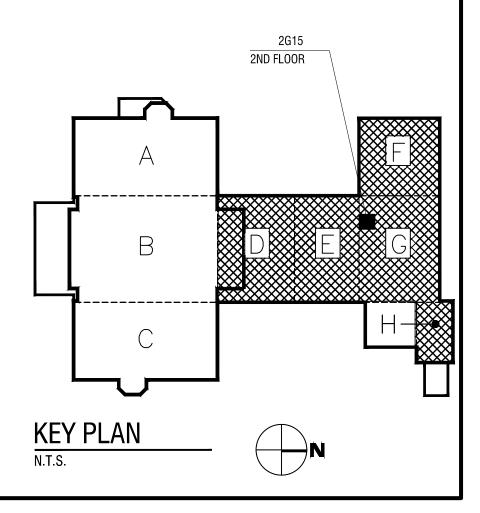



DRAWING NUMBER:

AREAS: D, E, F, G, & H

DRAWING NAME:

| ROOF SPECIAL |
|---------------------|
| SYSTEMS PLAN- |
| |

| REVISIONS | | | | | | |
|------------------|---------|----------------|--|--|--|--|
| NO: | DATE: | DESCRIPTION: | | | | |
| _ | - | - | | | | |
| 1 | 6.28.19 | BID ADDENDUM 1 | | | | |
| | | | | | | |
| | | | | | | |
| PROJECT N | IUMBER: | | | | | |
| | | 2170218 | | | | |
| DRAWN BY: MHB | | | | | | |
| REVIEWED BY: MVR | | | | | | |
| | | | | | | |
| ISSUED FOR: | | | | | | |
| BID DOCUMENTS | | | | | | |
| | | | | | | |
| DATE: | | UNE 26, 2019 | | | | |

SED NO. 26-16-00-01-0-111-032 DWT NO. 26-16-00-01-7-999-020

655 COLFAX STREET ROCHESTER, NY 14606

EDISON TECHNICAL SCHOOL

MODERNIZATION PROGRAM 1776 N. CLINTON AVE ROCHESTER, NY 14621

ROCHESTER SCHOOLS

© 2019 LaBella Associates

an architect, engineer, or land surveyor is altered; the altering architect, engineer, or land surveyor shall affix to the item their seal and notation "altered by" followed by their signature and date of such alteration, and a specific description of the alteration.

It is a violation of New York Education Law Article 145 Sec.7209, for any person, unless acting under the direction of a licensed architect, professional engineer, or land surveyor, to alter an item in any way. If an item bearing the seal of

labellapc.com RSN in association with azak Associate


Powered by partnershi

300 State Street, Suite 201


Rochester, NY 14614

585-454-6110



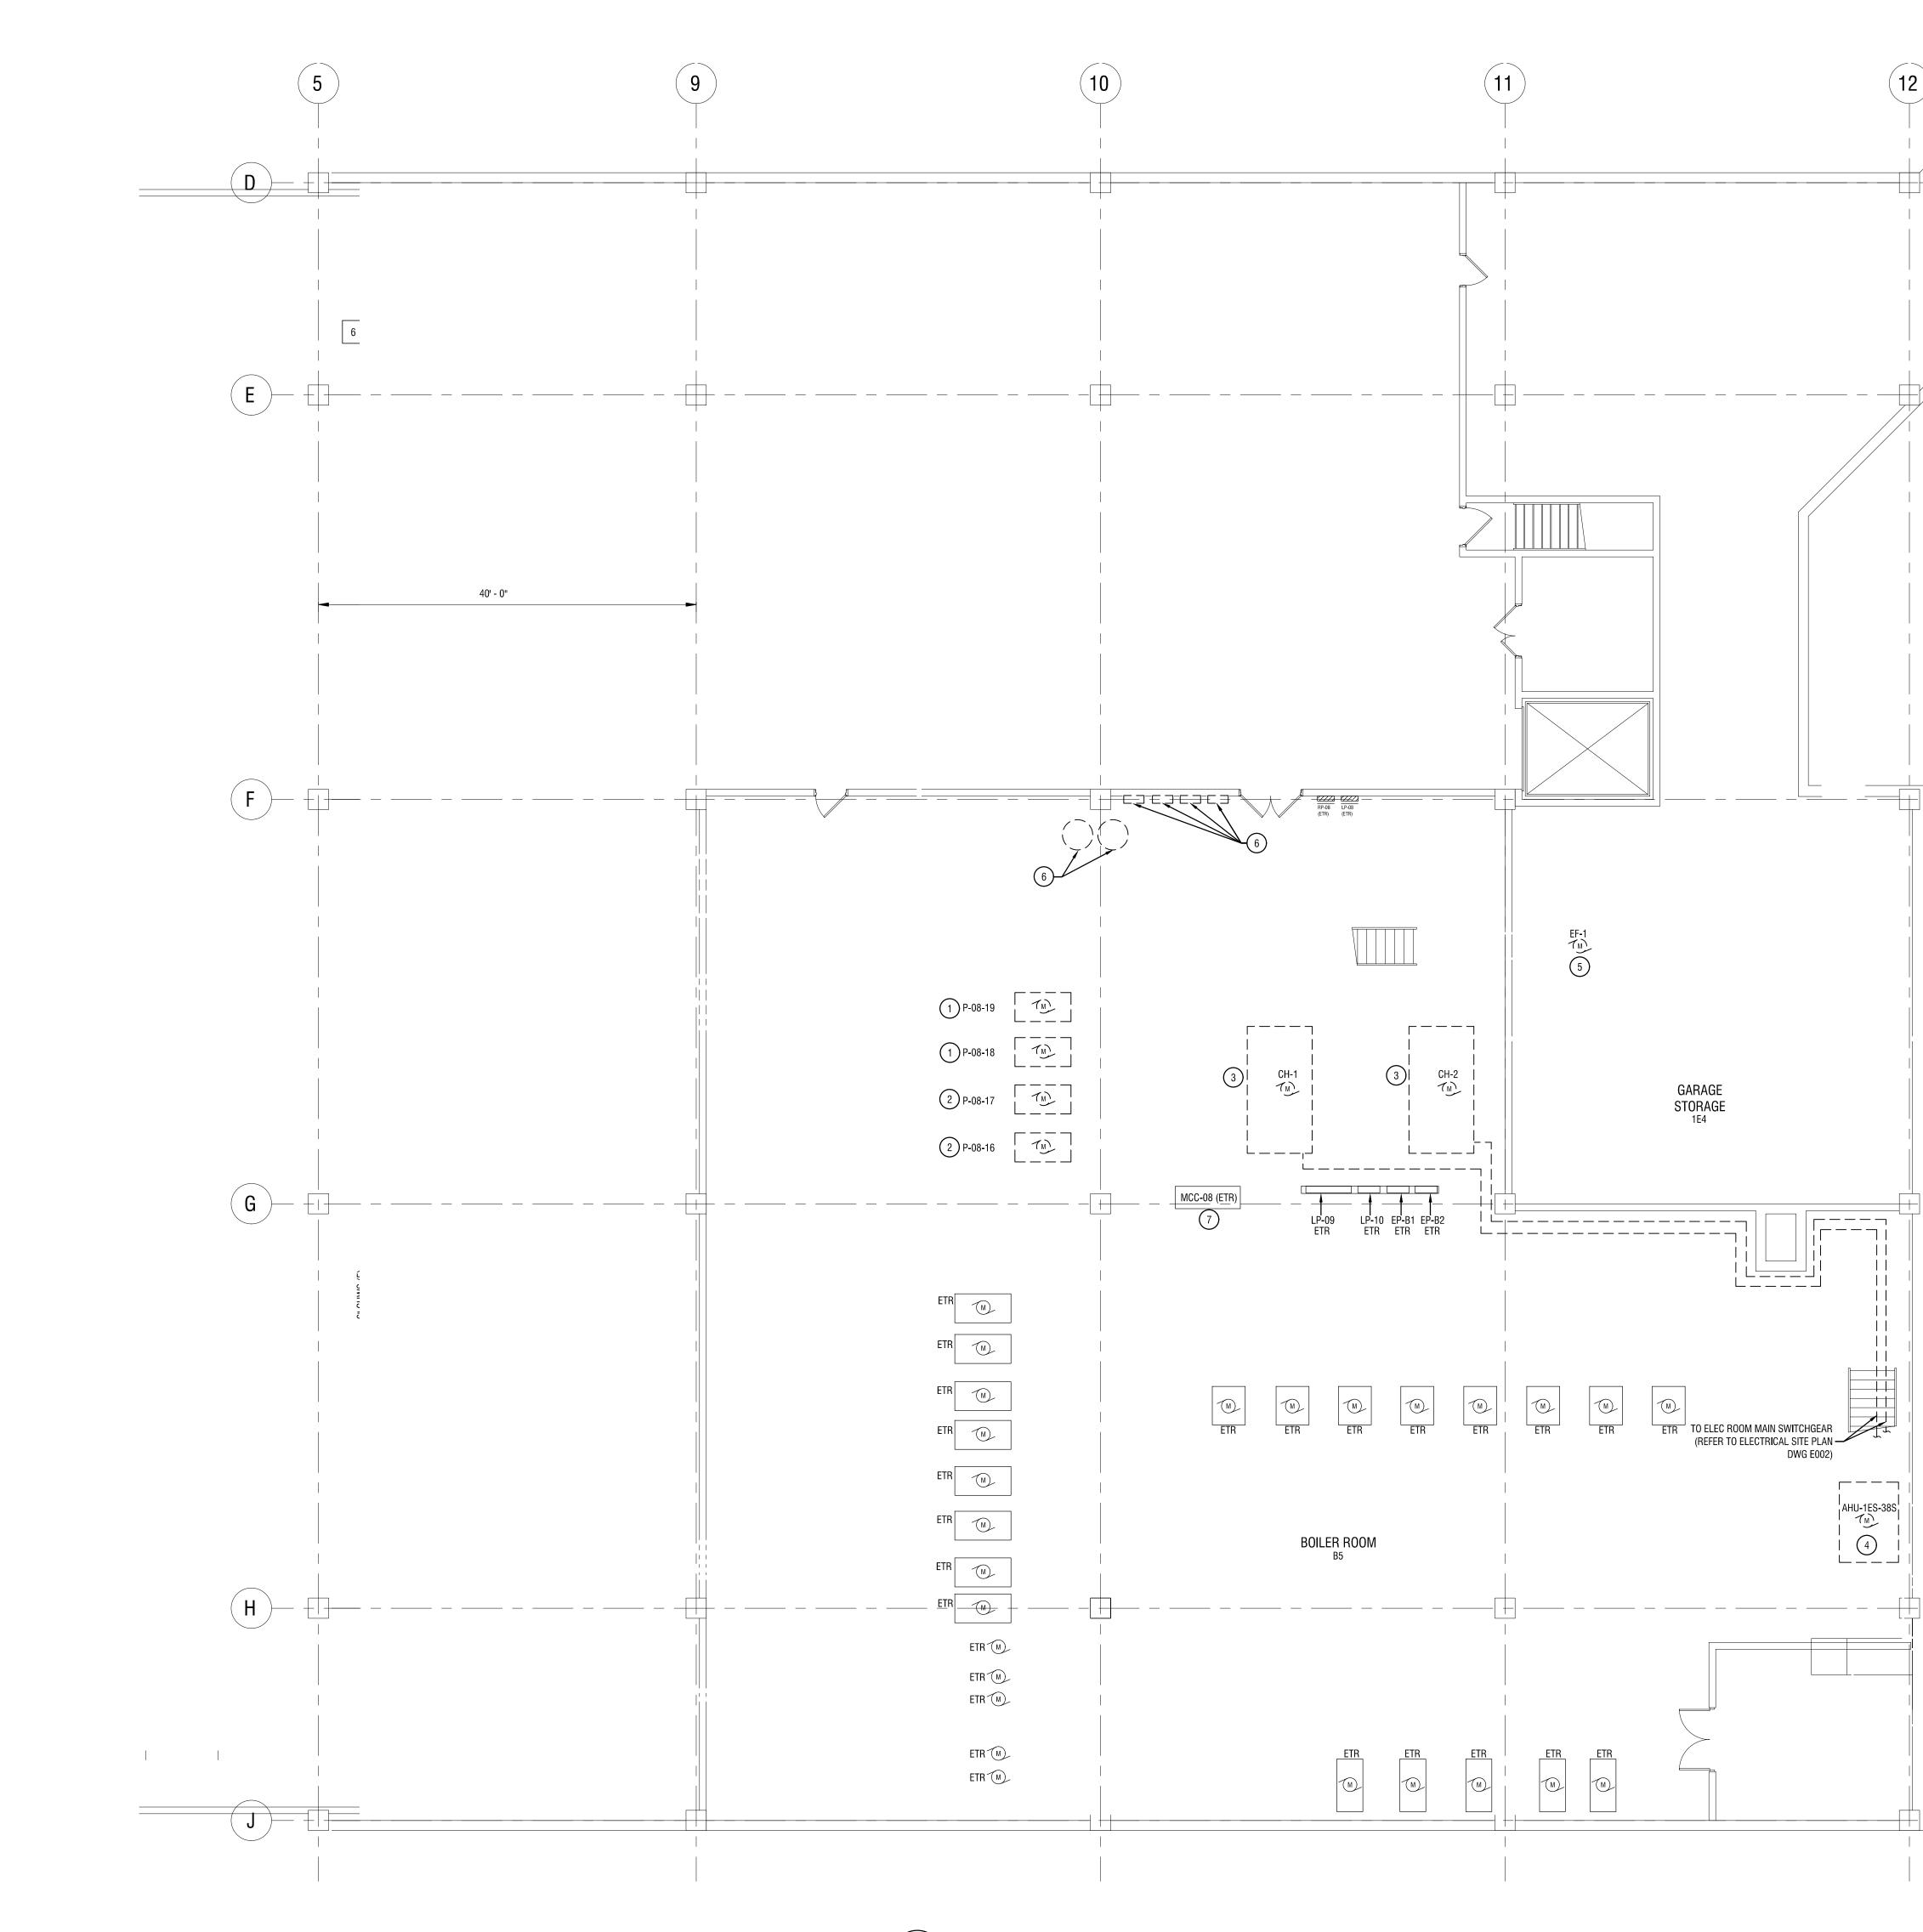


1 MECHANICAL ROOM ELECTRICAL DEMOLITION PLAN E101 1/8"=1'-0"

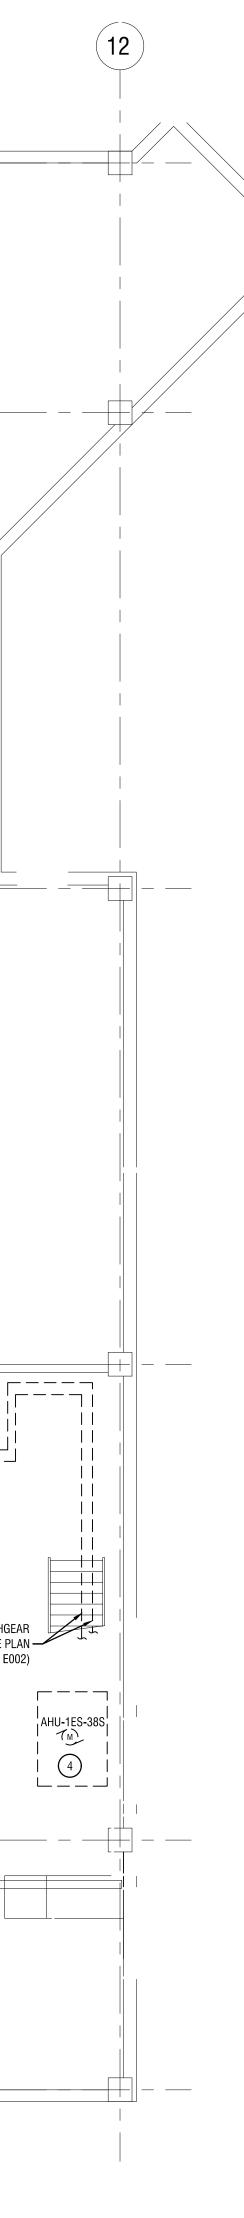

ELECTRIC DEMOLITION NOTES:

- 1 REMOVE POWER TO EXISTING PUMP, DISCONNECT SWITCH AND ALL ASSOCIATED WIRING BACK TO LP-09.
- (2) REMOVE POWER TO EXISTING PUMP AND WIRING BACK TO MCC-08.
- 3 REMOVE POWER TO EXISTING CHILLER UNIT, WIRING BACK TO MAIN SWITCHGEAR, DISCONNECT AND BREAKER.
- (4) REMOVE POWER TO EXISTING AHU, DISCONNECT AND WIRING BACK TO MCC-08.
- 5 REMOVE POWER TO EXISTING EXHAUST FAN, DISCONNECT AND WIRING BACK TO LP-08.
- 6 REMOVE POWER TO EXISTING EQUIPMENT AND ELECTRICAL CONNECTIONS.
- 7 REMOVE MOTOR CONTROLS FOR UNITS BEING REPLACED FROM MCC TUBES. PROVIDE NEW REPLACEMENT BREAKERS AS INDICATED IN SCHEDULE IN DWG E000.

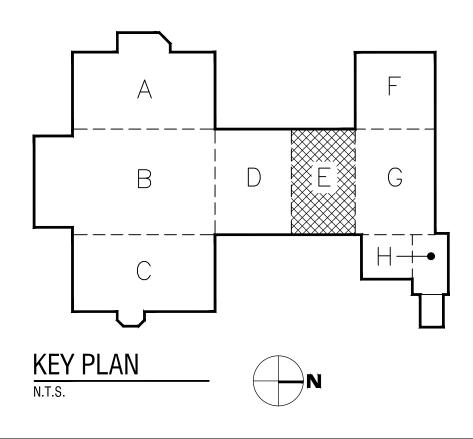



DRAWING NUMBER:

DRAWING NAME:

MECHANICAL ROOM ELECTRICAL DEMOLITION PLAN

| DWT NO. 26-16-00-01-7-999-020 | | | | | | |
|-------------------------------|------------------------------|----------------|--|--|--|--|
| REVISION | S | | | | | |
| NO: | DATE: | DESCRIPTION: | | | | |
| _ | - | - | | | | |
| 1 | 6.28.19 | BID ADDENDUM 1 | | | | |
| | | | | | | |
| | | | | | | |
| PROJECT N | PROJECT NUMBER: 2170218 | | | | | |
| DRAWN BY | DRAWN BY: | | | | | |
| REVIEWED BY: | | MHB | | | | |
| | MVR | | | | | |
| ISSUED FU | ISSUED FOR: BID DOCUMENTS | | | | | |
| DATE: | DATE: JUNE 26, 2019 | | | | | |

SED NO. 26-16-00-01-0-111-032

655 COLFAX STREET ROCHESTER, NY 14606

EDISON TECHNICAL SCHOOL

MODERNIZATION PROGRAM 1776 N. CLINTON AVE ROCHESTER, NY 14621

© 2019 LaBella Associates

ROCHESTER SCHOOLS

description of the alteration.

It is a violation of New York Education Law Article 145 Sec.7209, for any person, unless acting under the direction of a licensed architect, acting under the direction of a licensed architect, professional engineer, or land surveyor, to alter an item in any way. If an item bearing the seal of an architect, engineer, or land surveyor is altered; the altering architect, engineer, or land surveyor shall affix to the item their seal and notation "altered by" followed by their signature and date of such alteration, and a specific description of the alteration


2000 EAIRPORT-NINE MILE POINT ROAD, SUITE 41 PENTELD, NY 14520 PHONE, 585.377.3550 • FAX. 586.377.3559 555 Penbrooke Drive • Penfield, NY 14526 main: 585.388.2060 • fax: 585.388.2070

RSM in association with Savin Eng Razak Associates ARCHITECTURE ENGINEERING LAND SURVEYIN INTERIORS PLANNING LANDSCAPE

300 State Street, Suite 201 Rochester, NY 14614 585-454-6110

labellapc.com



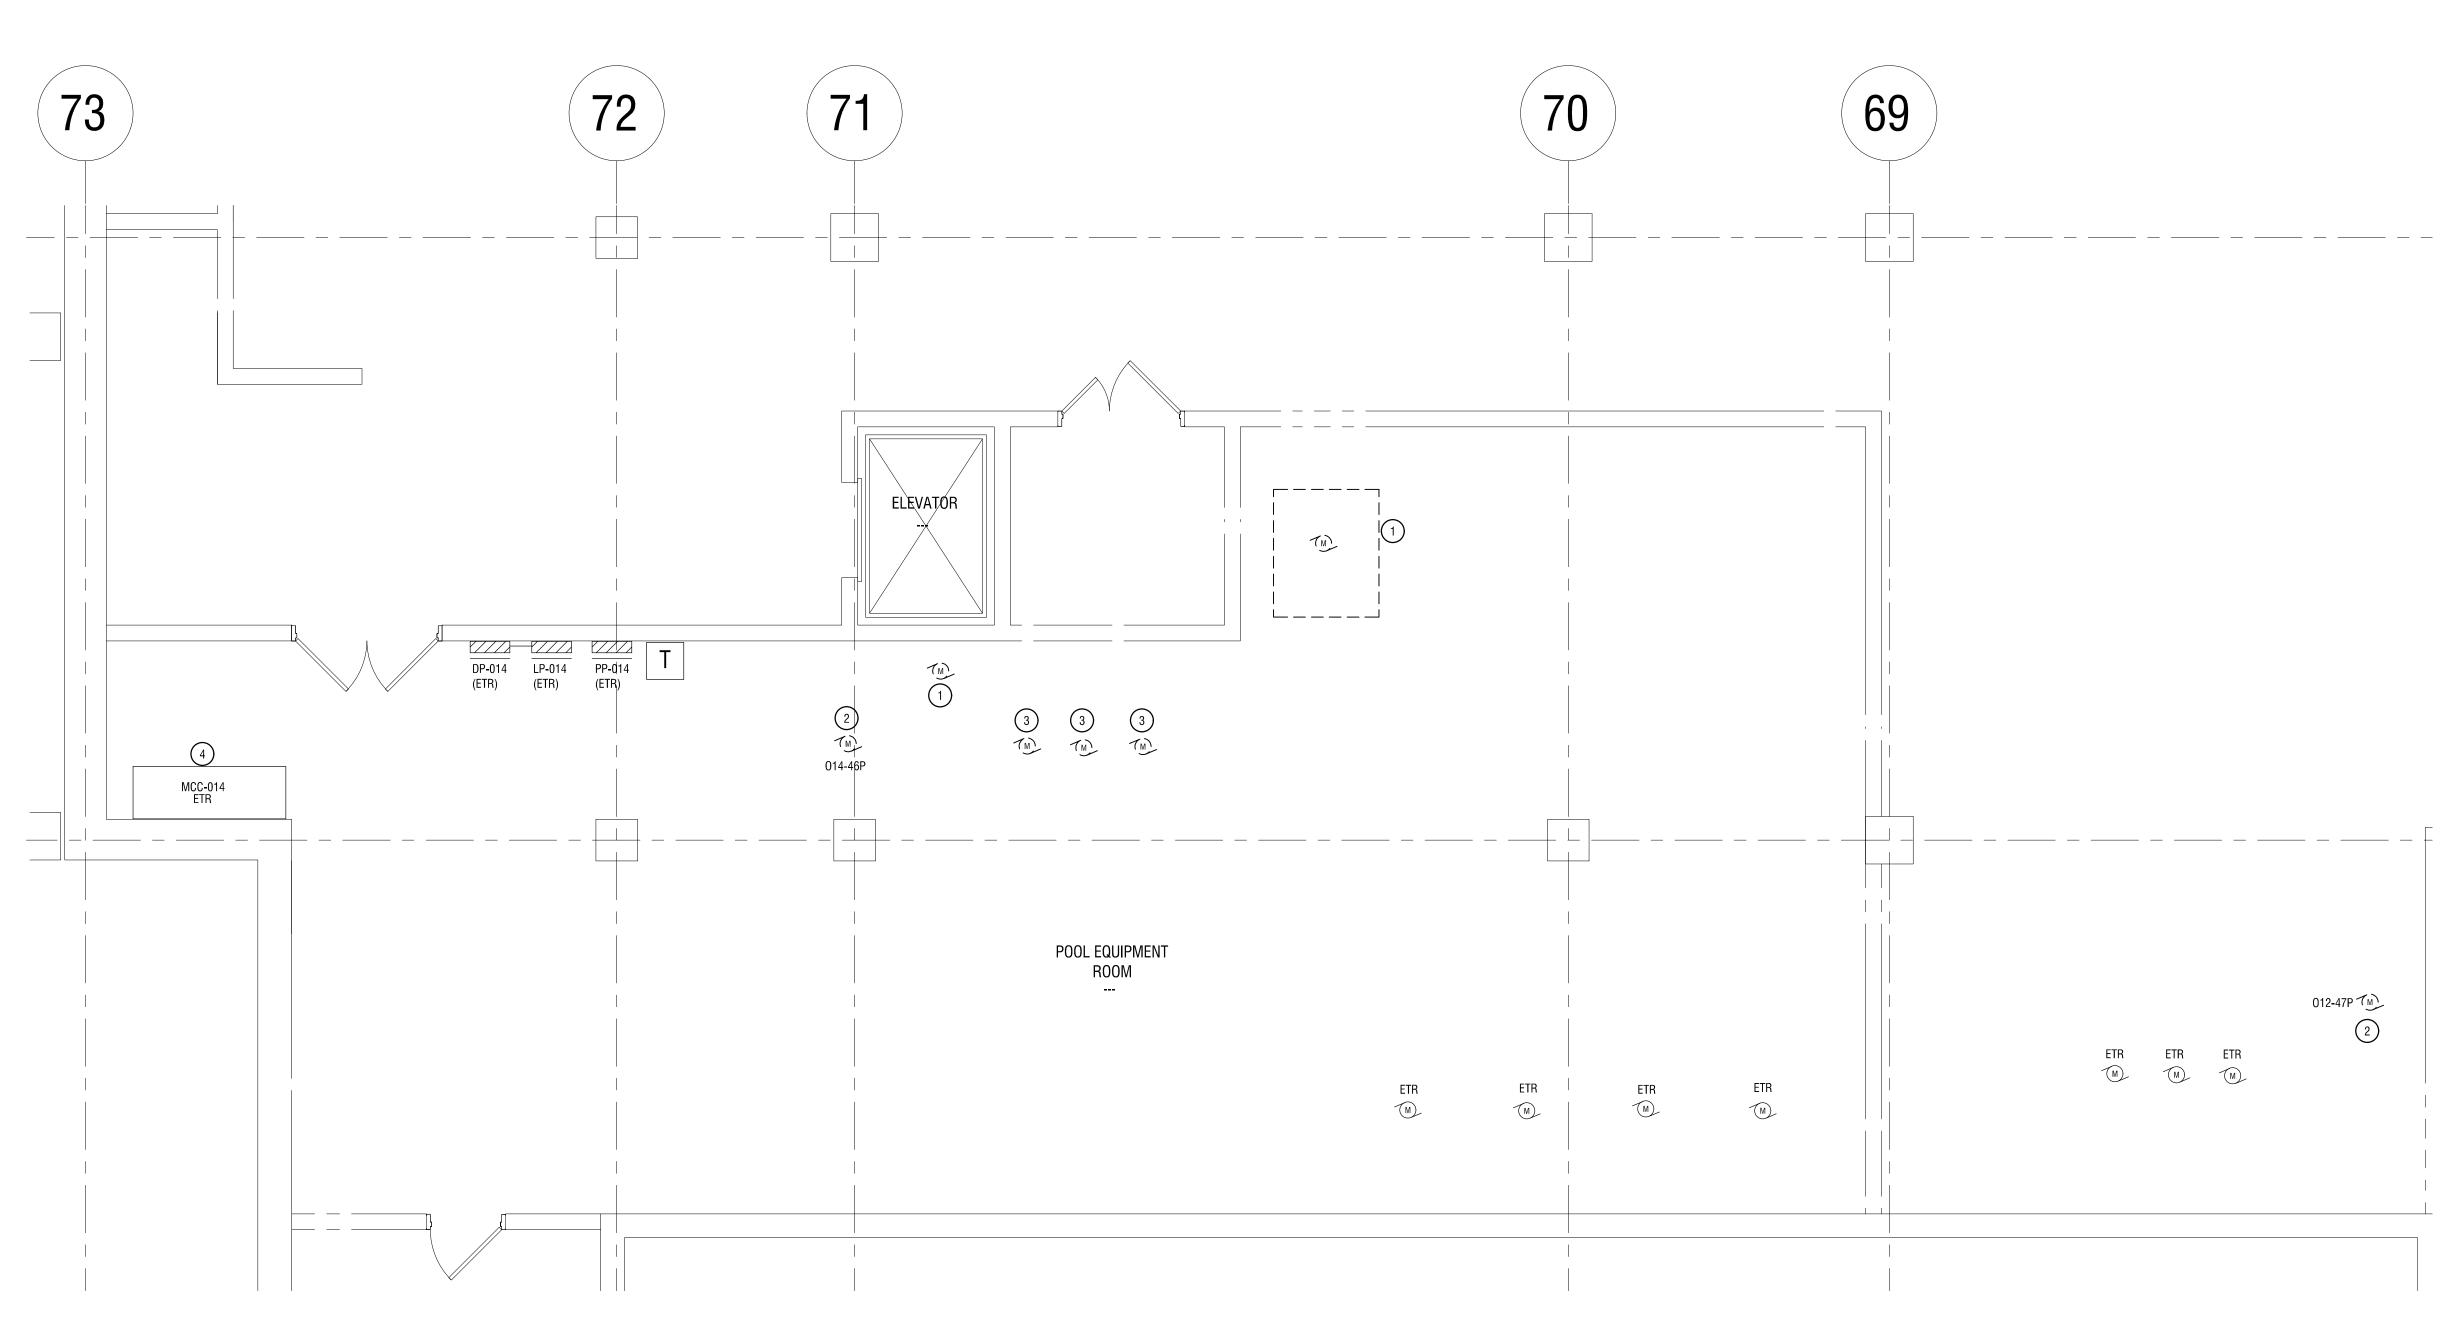


BASEMENT ELECTRICAL DEMOLITION PLAN- AREA G/H E102 1/4"=1'-0"

ELECTRIC DEMOLITION NOTES:

SCHEDULE IN DWG E000.

- 1 REMOVE POWER TO EXISTING DEHUMIDIFIER, PUMP, DISCONNECT SWITCH AND ALL ASSOCIATED WIRING BACK TO LP-014.
- (2) REMOVE POWER TO EXISTING PUMP, DISCONNECT AND WIRING BACK TO
- MCC-014. 3 DISCONNECT POWER TO EQUIPMENT FOR NEW PIPING WORK AND RECONNECT ONCE NEW PIPING WORK IS COMPLETED.
- 4 REMOVE MOTOR CONTROLS FOR UNITS BEING REPLACED FROM MCC TUBES.PROVIDE NEW REPLACEMENT BREAKERS AS INDICATED IN

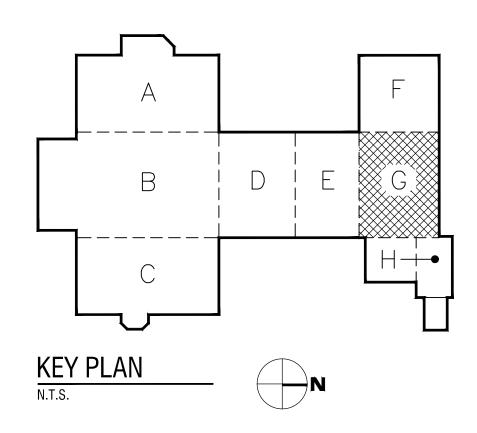



DRAWING NUMBER:

DRAWING NAME:

BASEMENT ELECTRICAL DEMOLITION PLAN- AREA G/H

| SED NO. 26-16-00-01-0-111-032 DWT NO. 26-16-00-01-7-999-020 | | | | | | | |
|--|---------|----------------|--|--|--|--|--|
| REVISIONS | | | | | | | |
| NO: | DATE: | DESCRIPTION: | | | | | |
| - | - | - | | | | | |
| 1 | 6.28.19 | BID ADDENDUM 1 | | | | | |
| | | | | | | | |
| | | | | | | | |
| PROJECT N | UMBER: | | | | | | |
| | | 2170218 | | | | | |
| DRAWN BY: MHB | | | | | | | |
| REVIEWED | BY: | MV/P | | | | | |
| MVR | | | | | | | |
| ISSUED FOR: BID DOCUMENTS | | | | | | | |
| DATE: JUNE 26, 2019 | | | | | | | |

655 COLFAX STREET ROCHESTER, NY 14606

EDISON TECHNICAL SCHOOL

Article 145 Sec.7209, for any person, unless acting under the direction of a licensed architect, professional engineer, or land surveyor, to alter an item in any way. If an item bearing the seal of an architect, engineer, or land surveyor is altered; the altering architect, engineer, or land surveyor shall affix to the item their seal and notation "altered by" followed by their signature and date of such alteration, and a specific description of the alteration. © 2019 LaBella Associates

ROCHESTER SCHOOLS

MODERNIZATION PROGRAM

1776 N. CLINTON AVE ROCHESTER, NY 14621


It is a violation of New York Education Law


RSMP in association with Razak Associates ARCHITECTUR INFORMATION 555 Penbrooke Drive • Penfield, NY 14526 main: 585.388.2060 • fax: 585.388.2070

300 State Street, Suite 201 Rochester, NY 14614 585-454-6110


labellapc.com



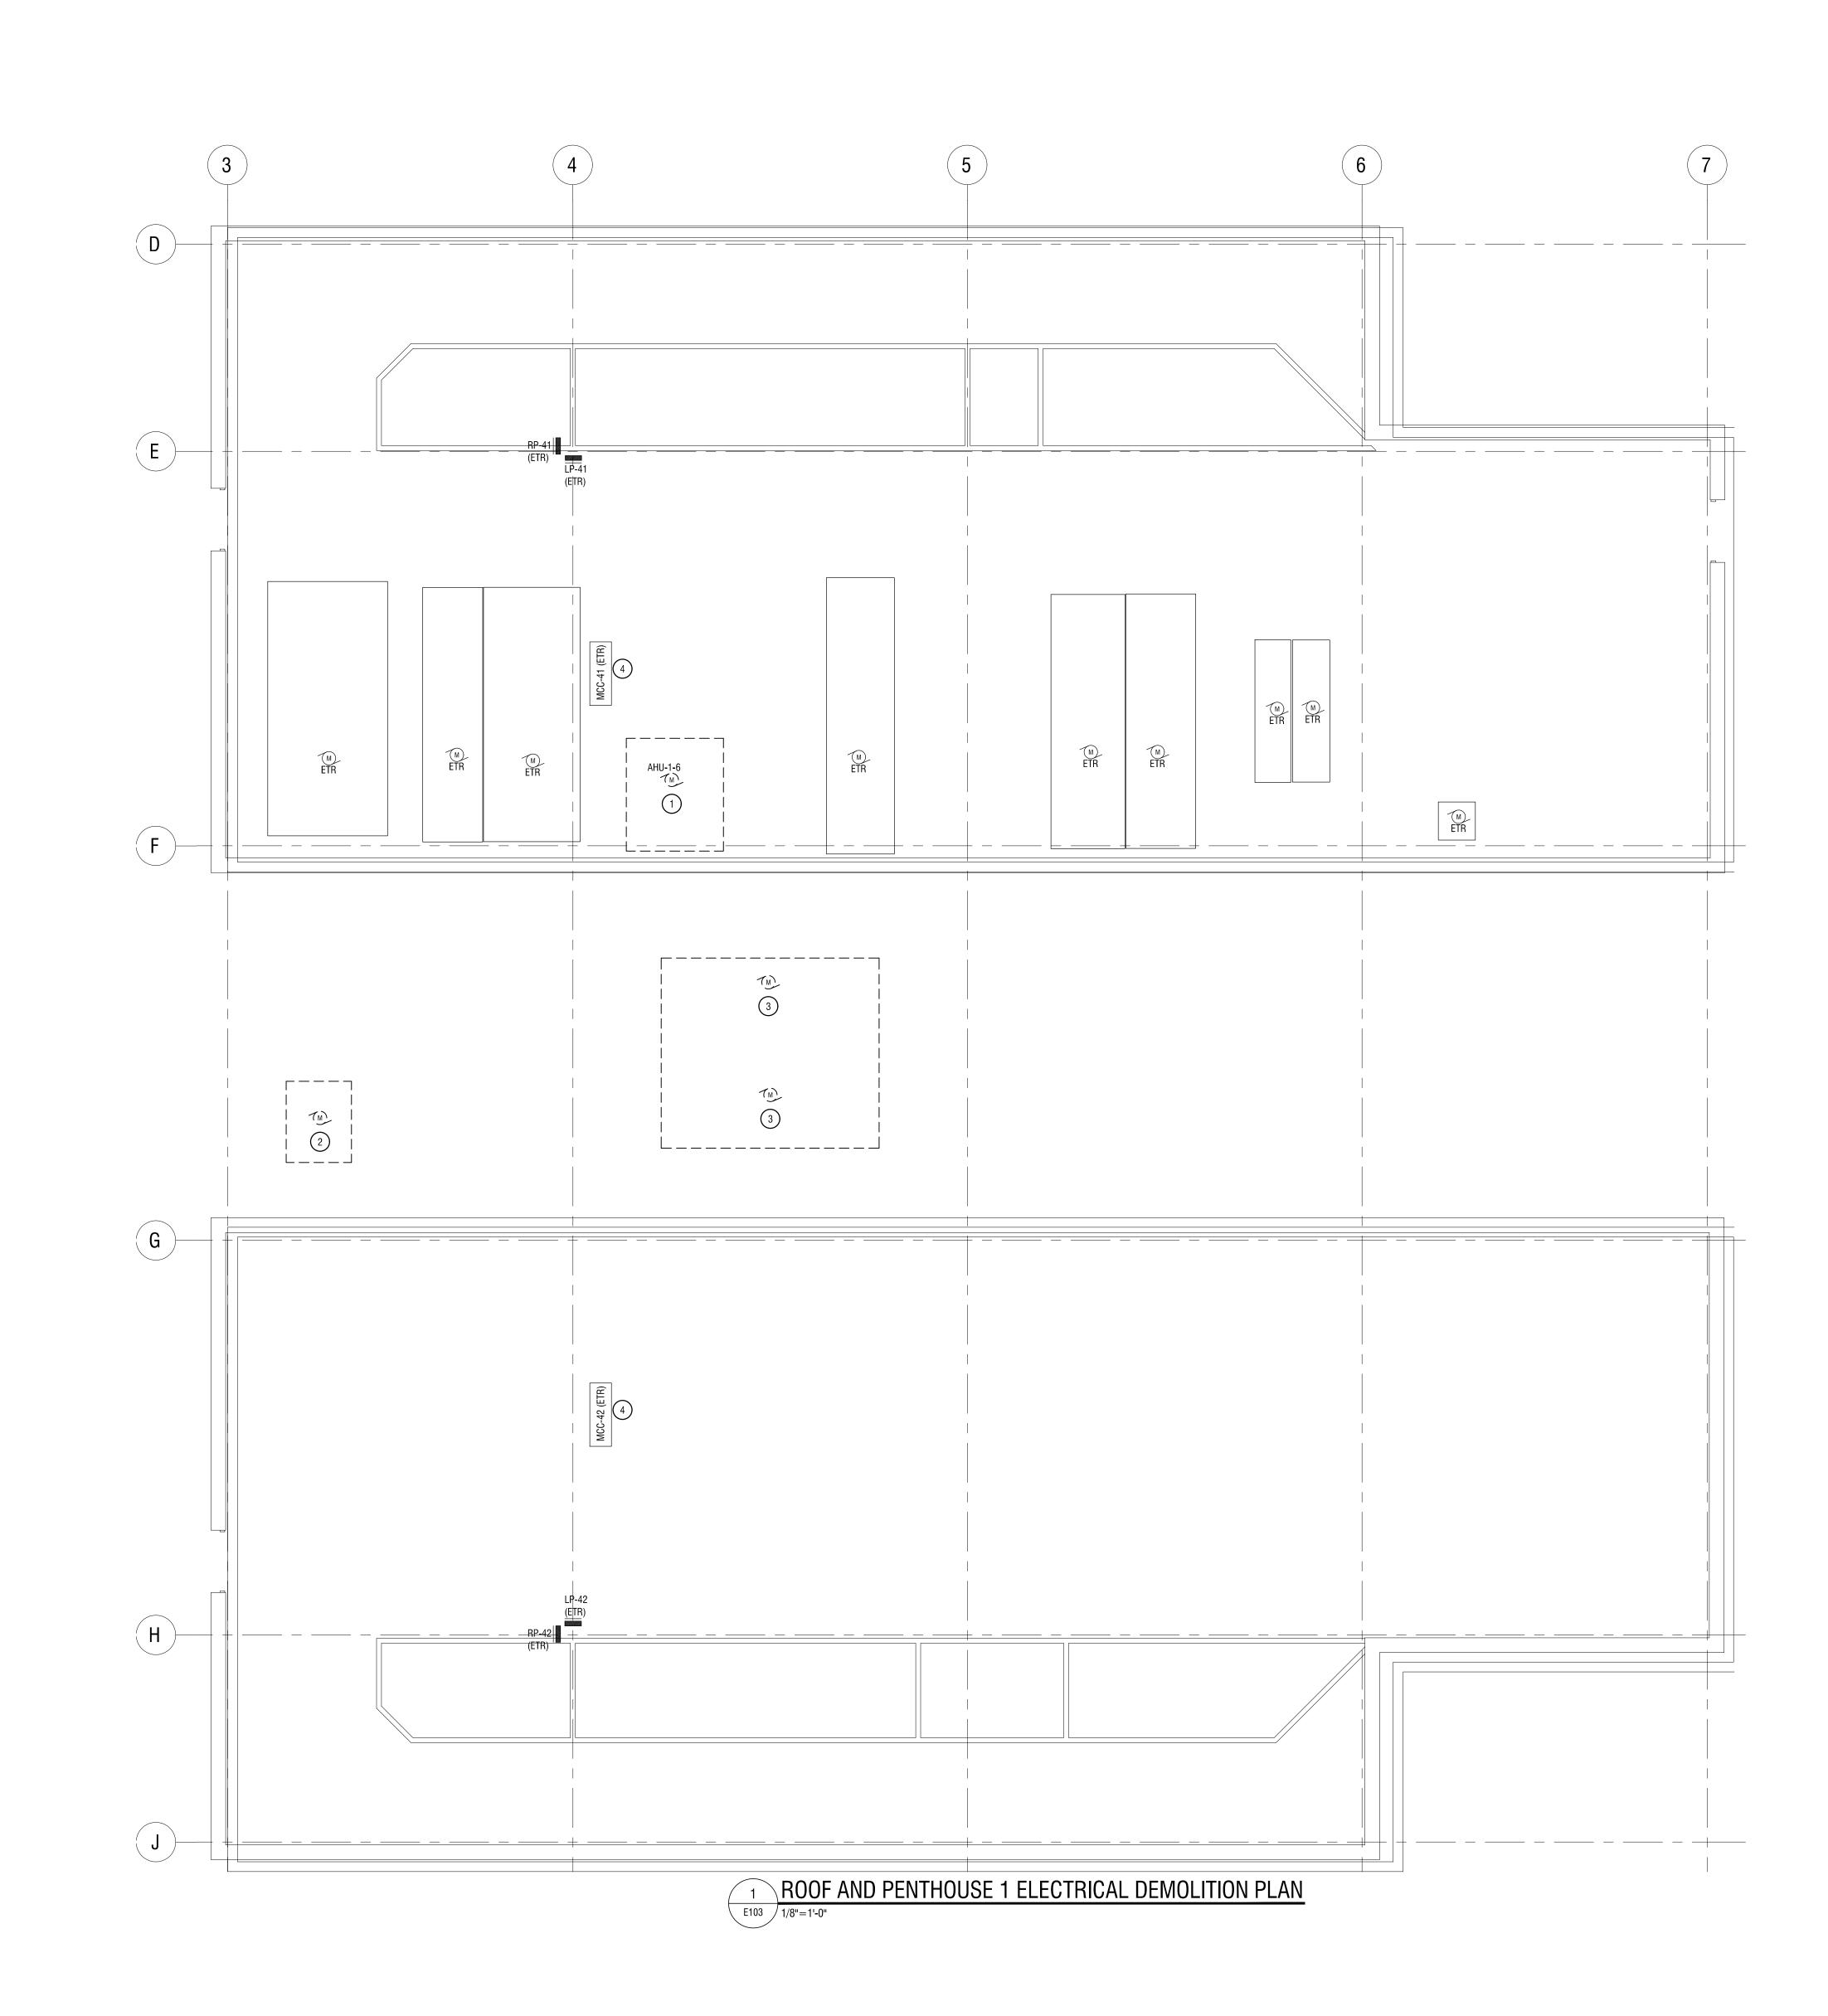

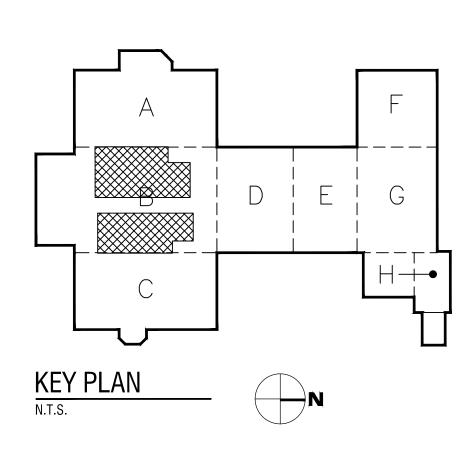


- DISCONNECT SWITCH.
 REMOVE MOTOR CONTROLS FOR UNITS BEING REPLACED FROM MCC TUBES. PROVIDE NEW REPLACEMENT BREAKERS AS INDICATED IN SCHEDULE IN DWG E000.
- 3 REMOVE POWER TO EXISTING COOLING TOWERS AND ASSOCIATED DISCONNECT SWITCH.
- 2 REMOVE POWER TO EXISTING CHILLER AND ASSOCIATED DISCONNECT SWITCH.
- 1 REMOVE POWER TO EXISTING AIR HANDLING UNIT, FAN ABOVE AND ASSOCIATED DISCONNECT SWITCH.
- ELECTRIC DEMOLITION NOTES:

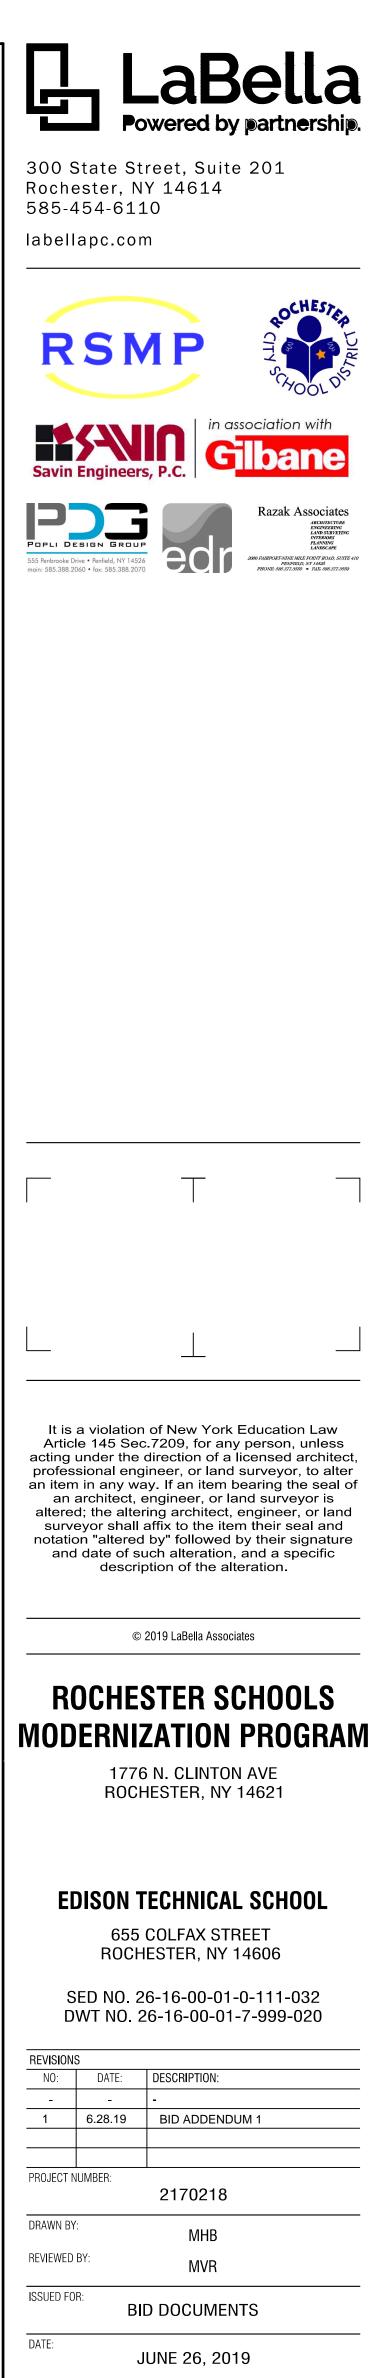


DRAWING NAME:


ROOF AND PENTHOUSE 1 ELECTRICAL DEMOLITION PLAN




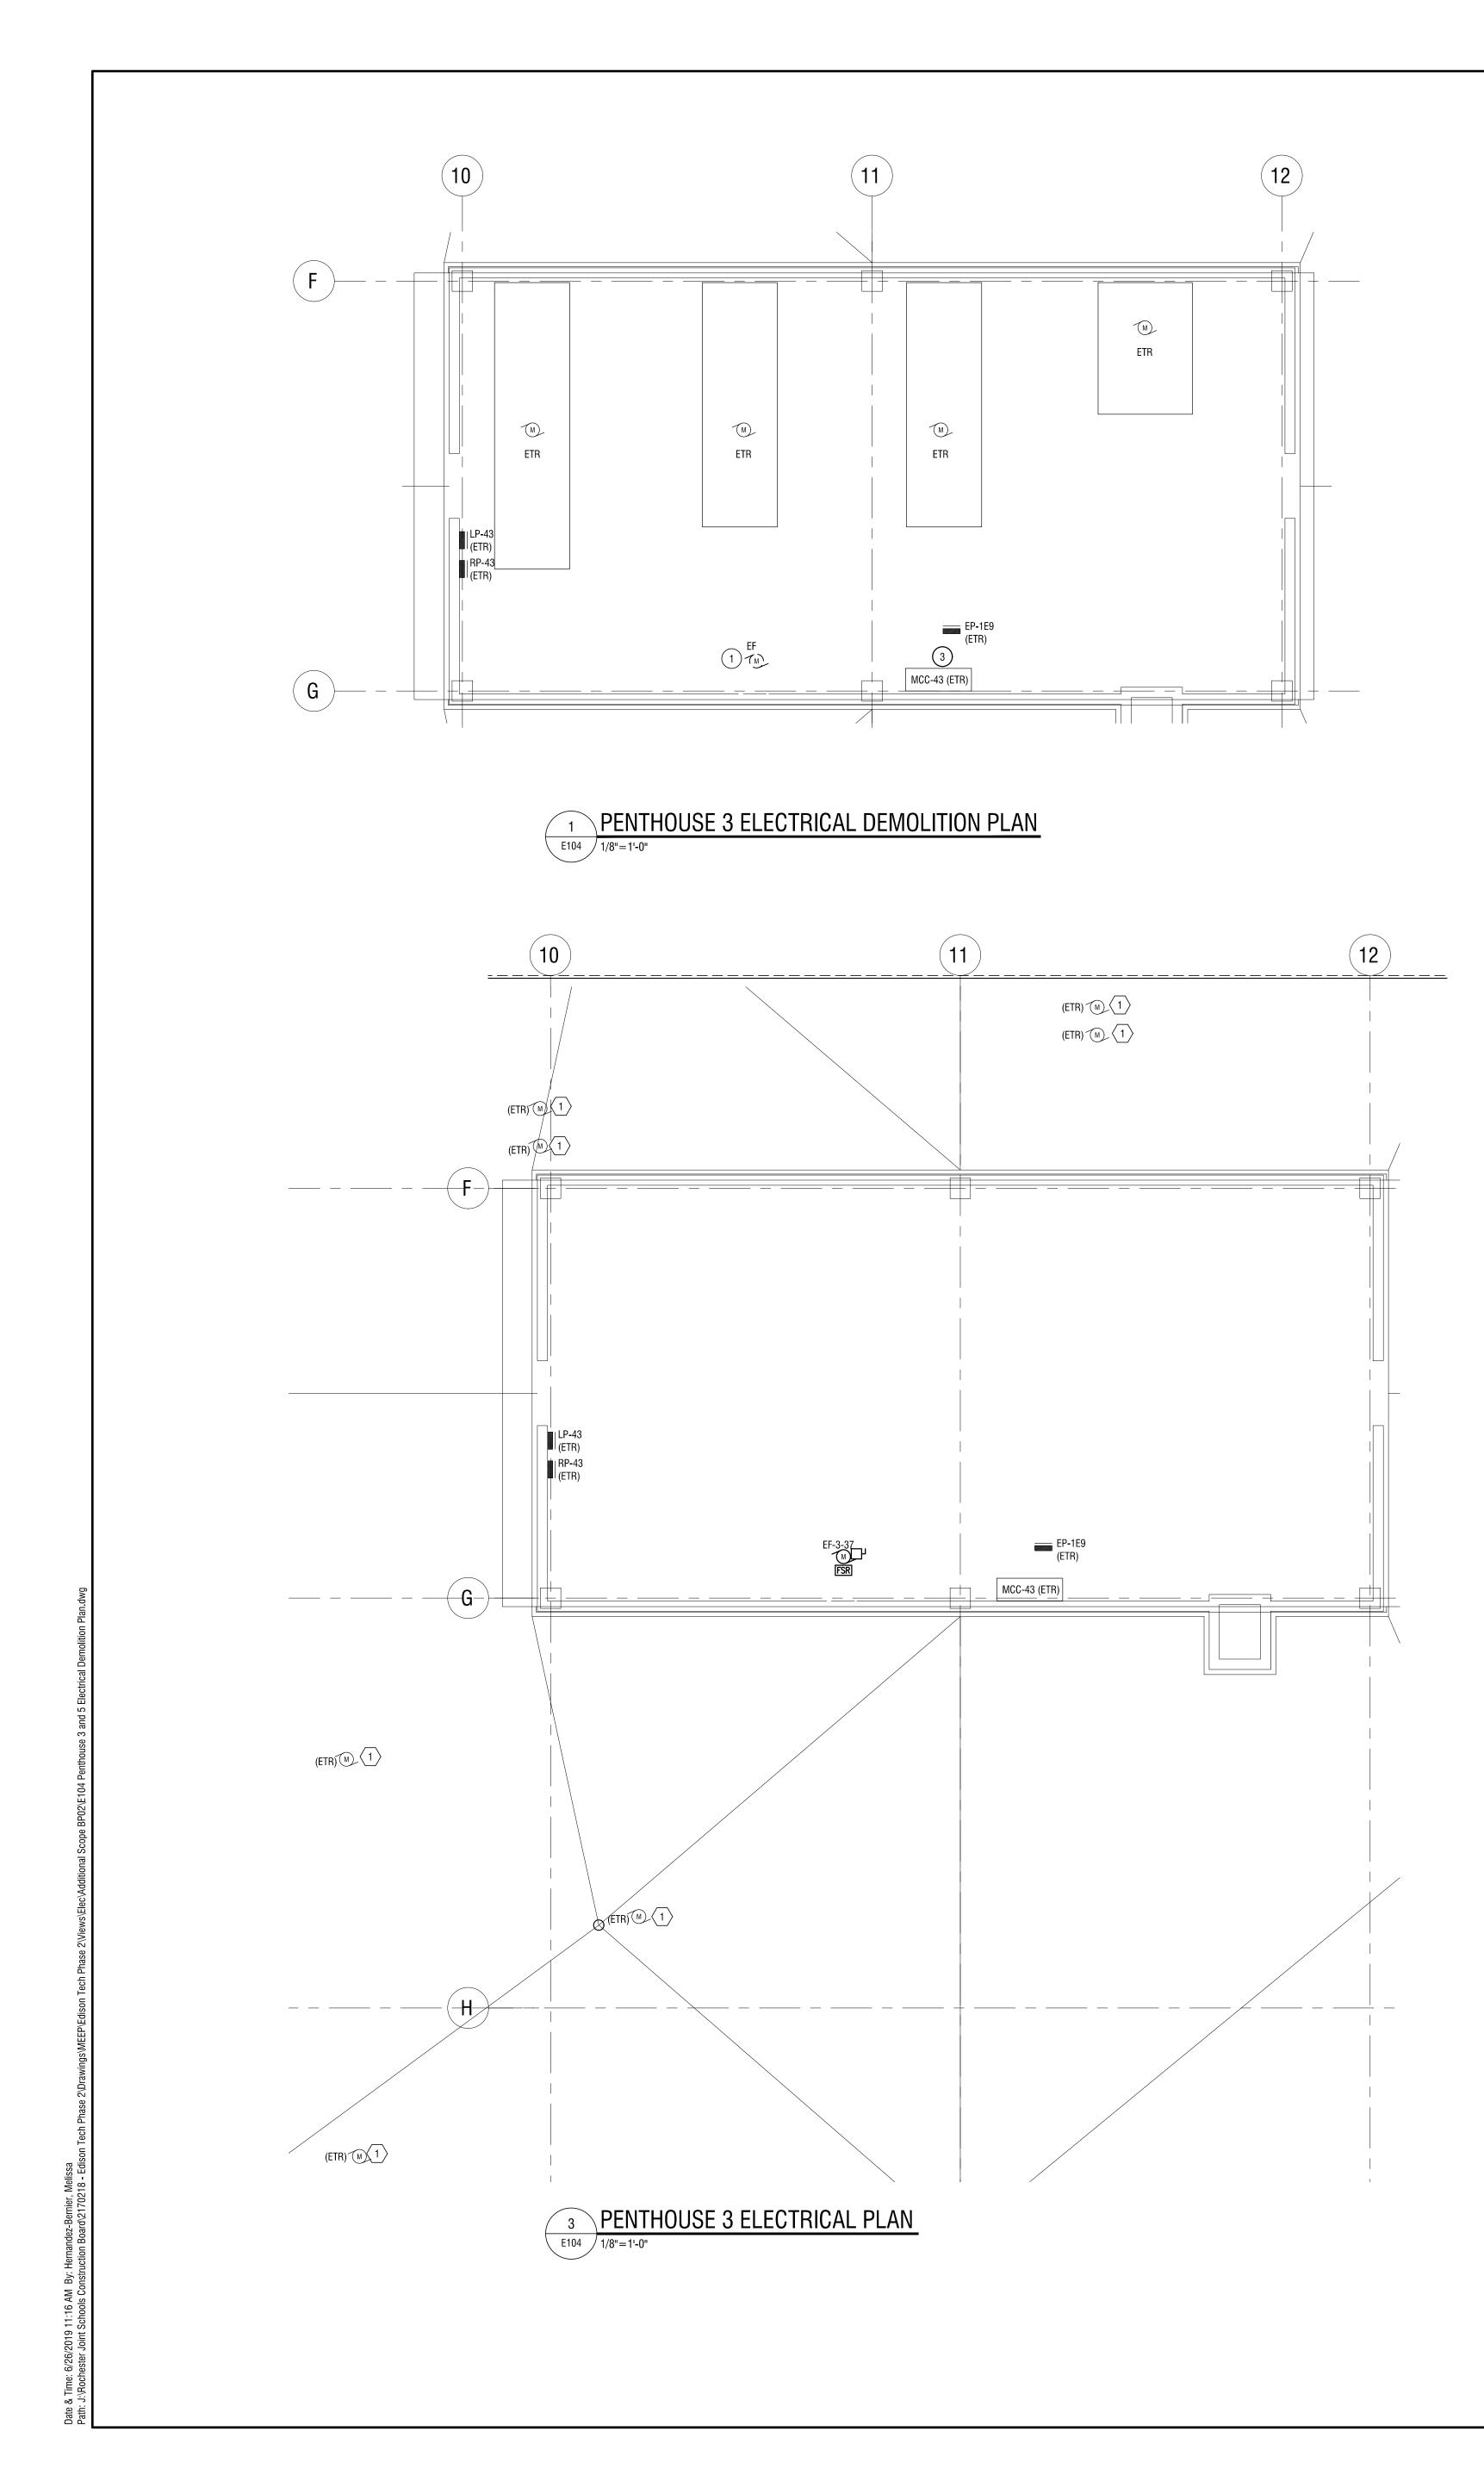

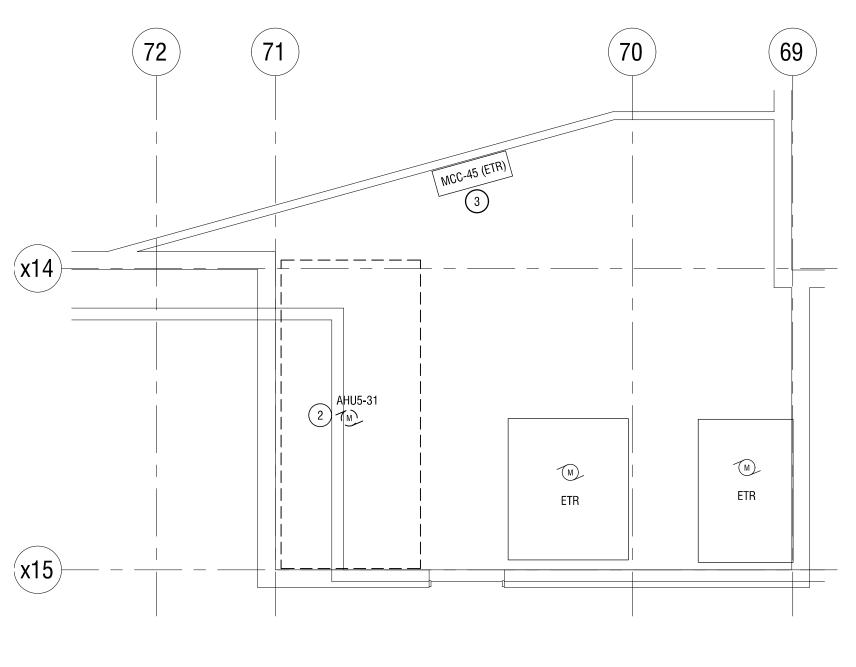



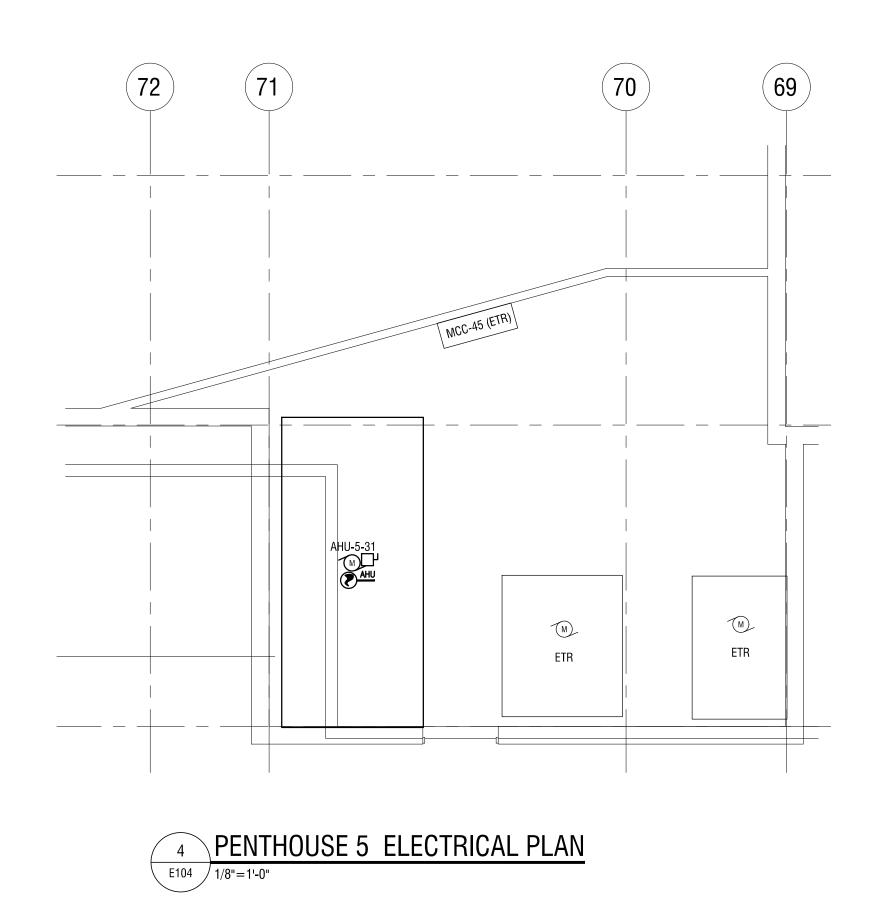

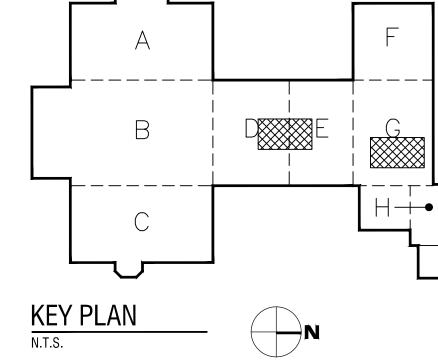

ELECTRIC KEYED NOTES: DISCONNECT POWER TO EXISTING EQUIPMENT. EXTEND EXISTING CIRCUITING AND RECONNECT UNIT. (REFER TO MECHANICAL DRAWINGS FOR DETAILS)

1. CONNECT FIRE ALARM DEVICE TO BUILDING ADDRESSABLE FIRE ALARM SYSTEM.

GENERAL NOTES:

2 REMOVE POWER TO EXISTING AHU AND ASSOCIATED DISCONNECT SWITCH. 3 REMOVE MOTOR CONTROLS FOR UNITS BEING REPLACED FROM MCC TUBES. PROVIDE NEW REPLACEMENT BREAKERS AS INDICATED IN SCHEDULE IN DWG E000.

1 REMOVE POWER TO EXISTING EXHAUST FAN AND ASSOCIATED DISCONNECT SWITCH.

ELECTRIC DEMOLITION NOTES:



DRAWING NUMBER:

PENTHOUSE 3 AND 5 ELECTRICAL DEMOLITION AND NEW WORK PLAN

| D | WT NO. 2 | 26-16-00-01-7-999-020 |
|-----------|----------|-----------------------|
| REVISION | S | |
| NO: | DATE: | DESCRIPTION: |
| _ | - | - |
| 1 | 6.28.19 | BID ADDENDUM 1 |
| | | |
| | | |
| PROJECT | NUMBER: | 2170218 |
| DRAWN BY | Y: | MHB |
| REVIEWED | BY: | MVR |
| ISSUED FC | | D DOCUMENTS |
| DATE: | , | JUNE 26, 2019 |
| DRAWING | NAME: | |

SED NO. 26-16-00-01-0-111-032

655 COLFAX STREET ROCHESTER, NY 14606

EDISON TECHNICAL SCHOOL

ROCHESTER, NY 14621

ROCHESTER SCHOOLS MODERNIZATION PROGRAM 1776 N. CLINTON AVE

© 2019 LaBella Associates

Article 145 Sec.7209, for any person, unless acting under the direction of a licensed architect, professional engineer, or land surveyor, to alter an item in any way. If an item bearing the seal of an architect, engineer, or land surveyor is altered; the altering architect, engineer, or land surveyor shall affix to the item their seal and notation "altered by" followed by their signature and date of such alteration, and a specific description of the alteration.

It is a violation of New York Education Law


Razak Associates Restriction BEREIN BEREIN

labellapc.com RSM Savin Engineers, P.C.

Powered by partnership

300 State Street, Suite 201 Rochester, NY 14614 585-454-6110



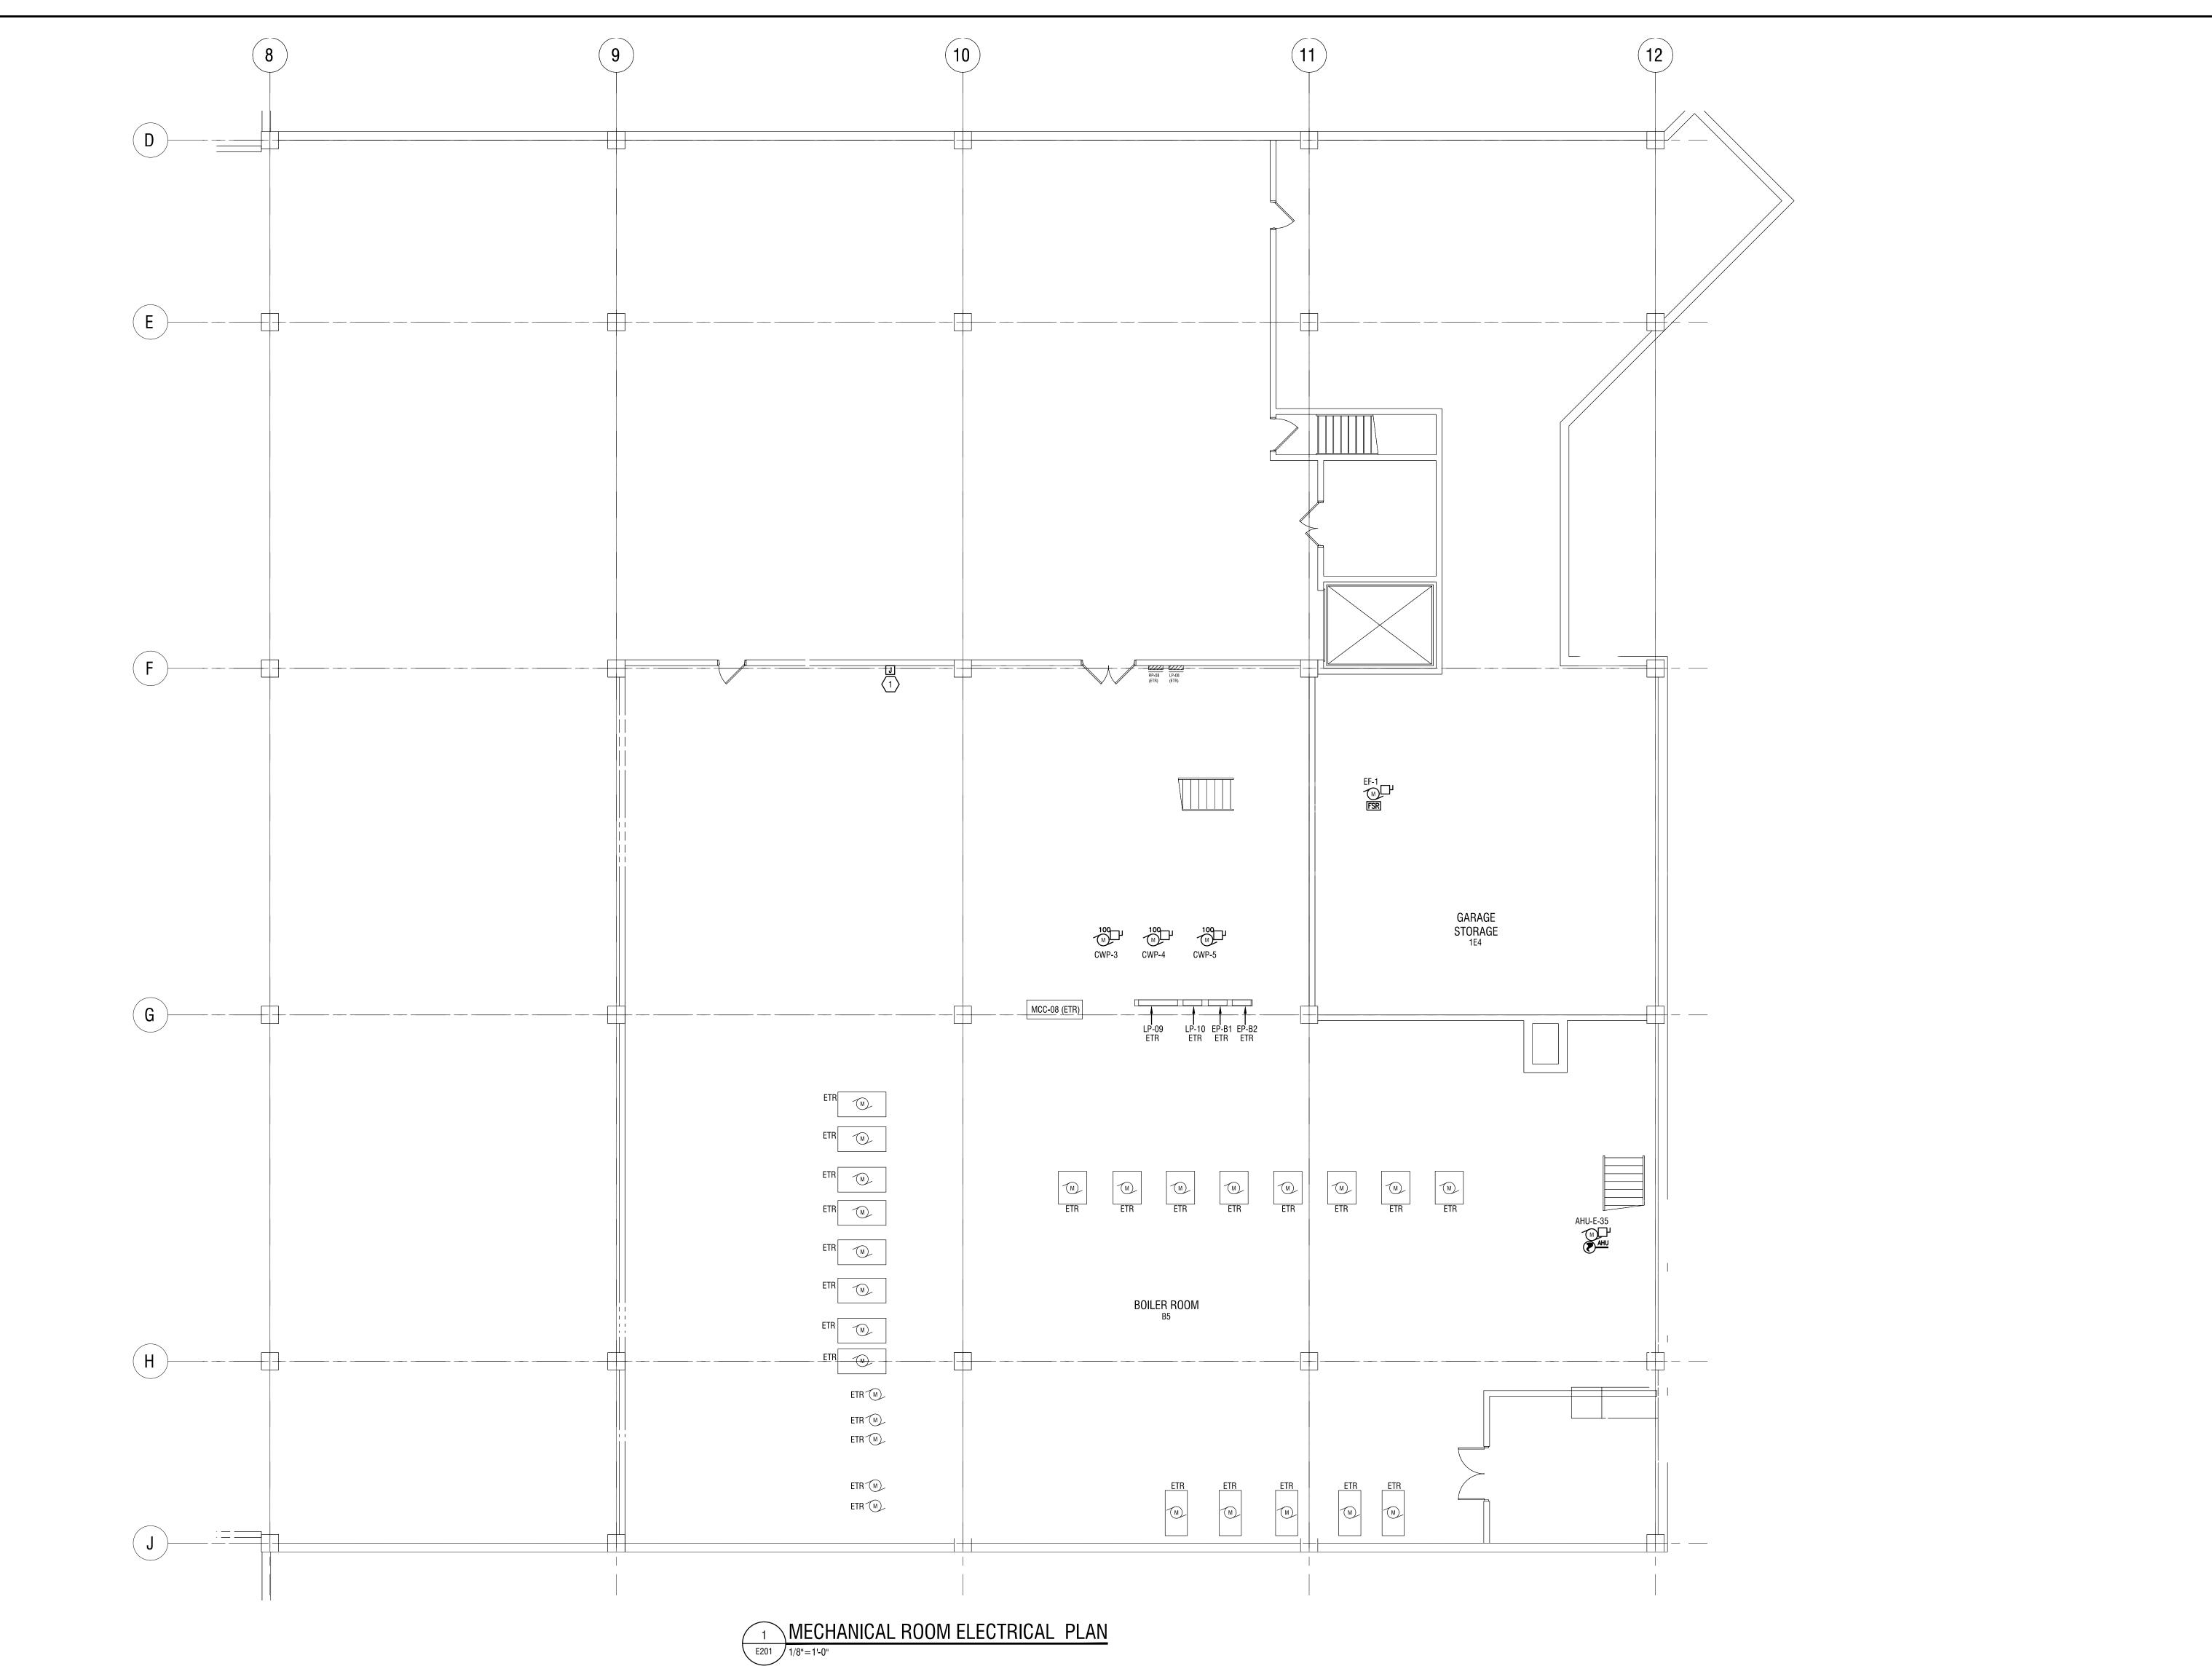


GENERAL NOTES:

1. CONNECT FIRE ALARM DEVICE TO BUILDING ADDRESSABLE FIRE ALARM SYSTEM.

ELECTRIC KEYED NOTES:

1 PROVIDE (1) 120V, 20A CIRCUIT FOR GLYCOL STATION POWER FROM CIRCUITS AVAILABLE FROM DEMOLITION WORK.

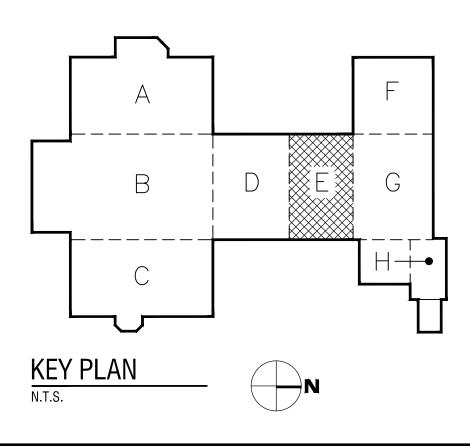



DRAWING NUMBER:

DRAWING NAME:

MECHANICAL ROOM ELECTRICAL PLAN

| DWT NO. 26-16-00-01-7-999-020 | | | | | | | |
|-------------------------------|-----------|----------------|--|--|--|--|--|
| REVISIONS | REVISIONS | | | | | | |
| NO: | DATE: | DESCRIPTION: | | | | | |
| - | _ | - | | | | | |
| 1 | 6.28.19 | BID ADDENDUM 1 | | | | | |
| | | | | | | | |
| | | | | | | | |
| PROJECT N | IUMBER: | 2170218 | | | | | |
| DRAWN BY | : | | | | | | |
| МНВ | | | | | | | |
| REVIEWED BY: MVR | | | | | | | |
| BID DOCUMENTS | | | | | | | |
| ATE: JUNE 26, 2019 | | | | | | | |

ROCHESTER, NY 14606 SED NO. 26-16-00-01-0-111-032

655 COLFAX STREET

EDISON TECHNICAL SCHOOL

1776 N. CLINTON AVE ROCHESTER, NY 14621

It is a violation of New York Education Law Article 145 Sec.7209, for any person, unless acting under the direction of a licensed architect, professional engineer, or land surveyor, to alter an item in any way. If an item bearing the seal of an architect, engineer, or land surveyor is altered; the altering architect, engineer, or land surveyor shall affix to the item their seal and notation "altered by" followed by their signature and date of such alteration, and a specific description of the alteration.

© 2019 LaBella Associates

ROCHESTER SCHOOLS

MODERNIZATION PROGRAM


____ _____

Razak Associates Result Design Group S55 Penbrooke Drive • Penfield, NY 14526 min: 585.388.2000 • fox: 585.388.2000

RSMP Savin Engineers, P.C.

Powered by partnership 300 State Street, Suite 201 Rochester, NY 14614 585-454-6110

labellapc.com

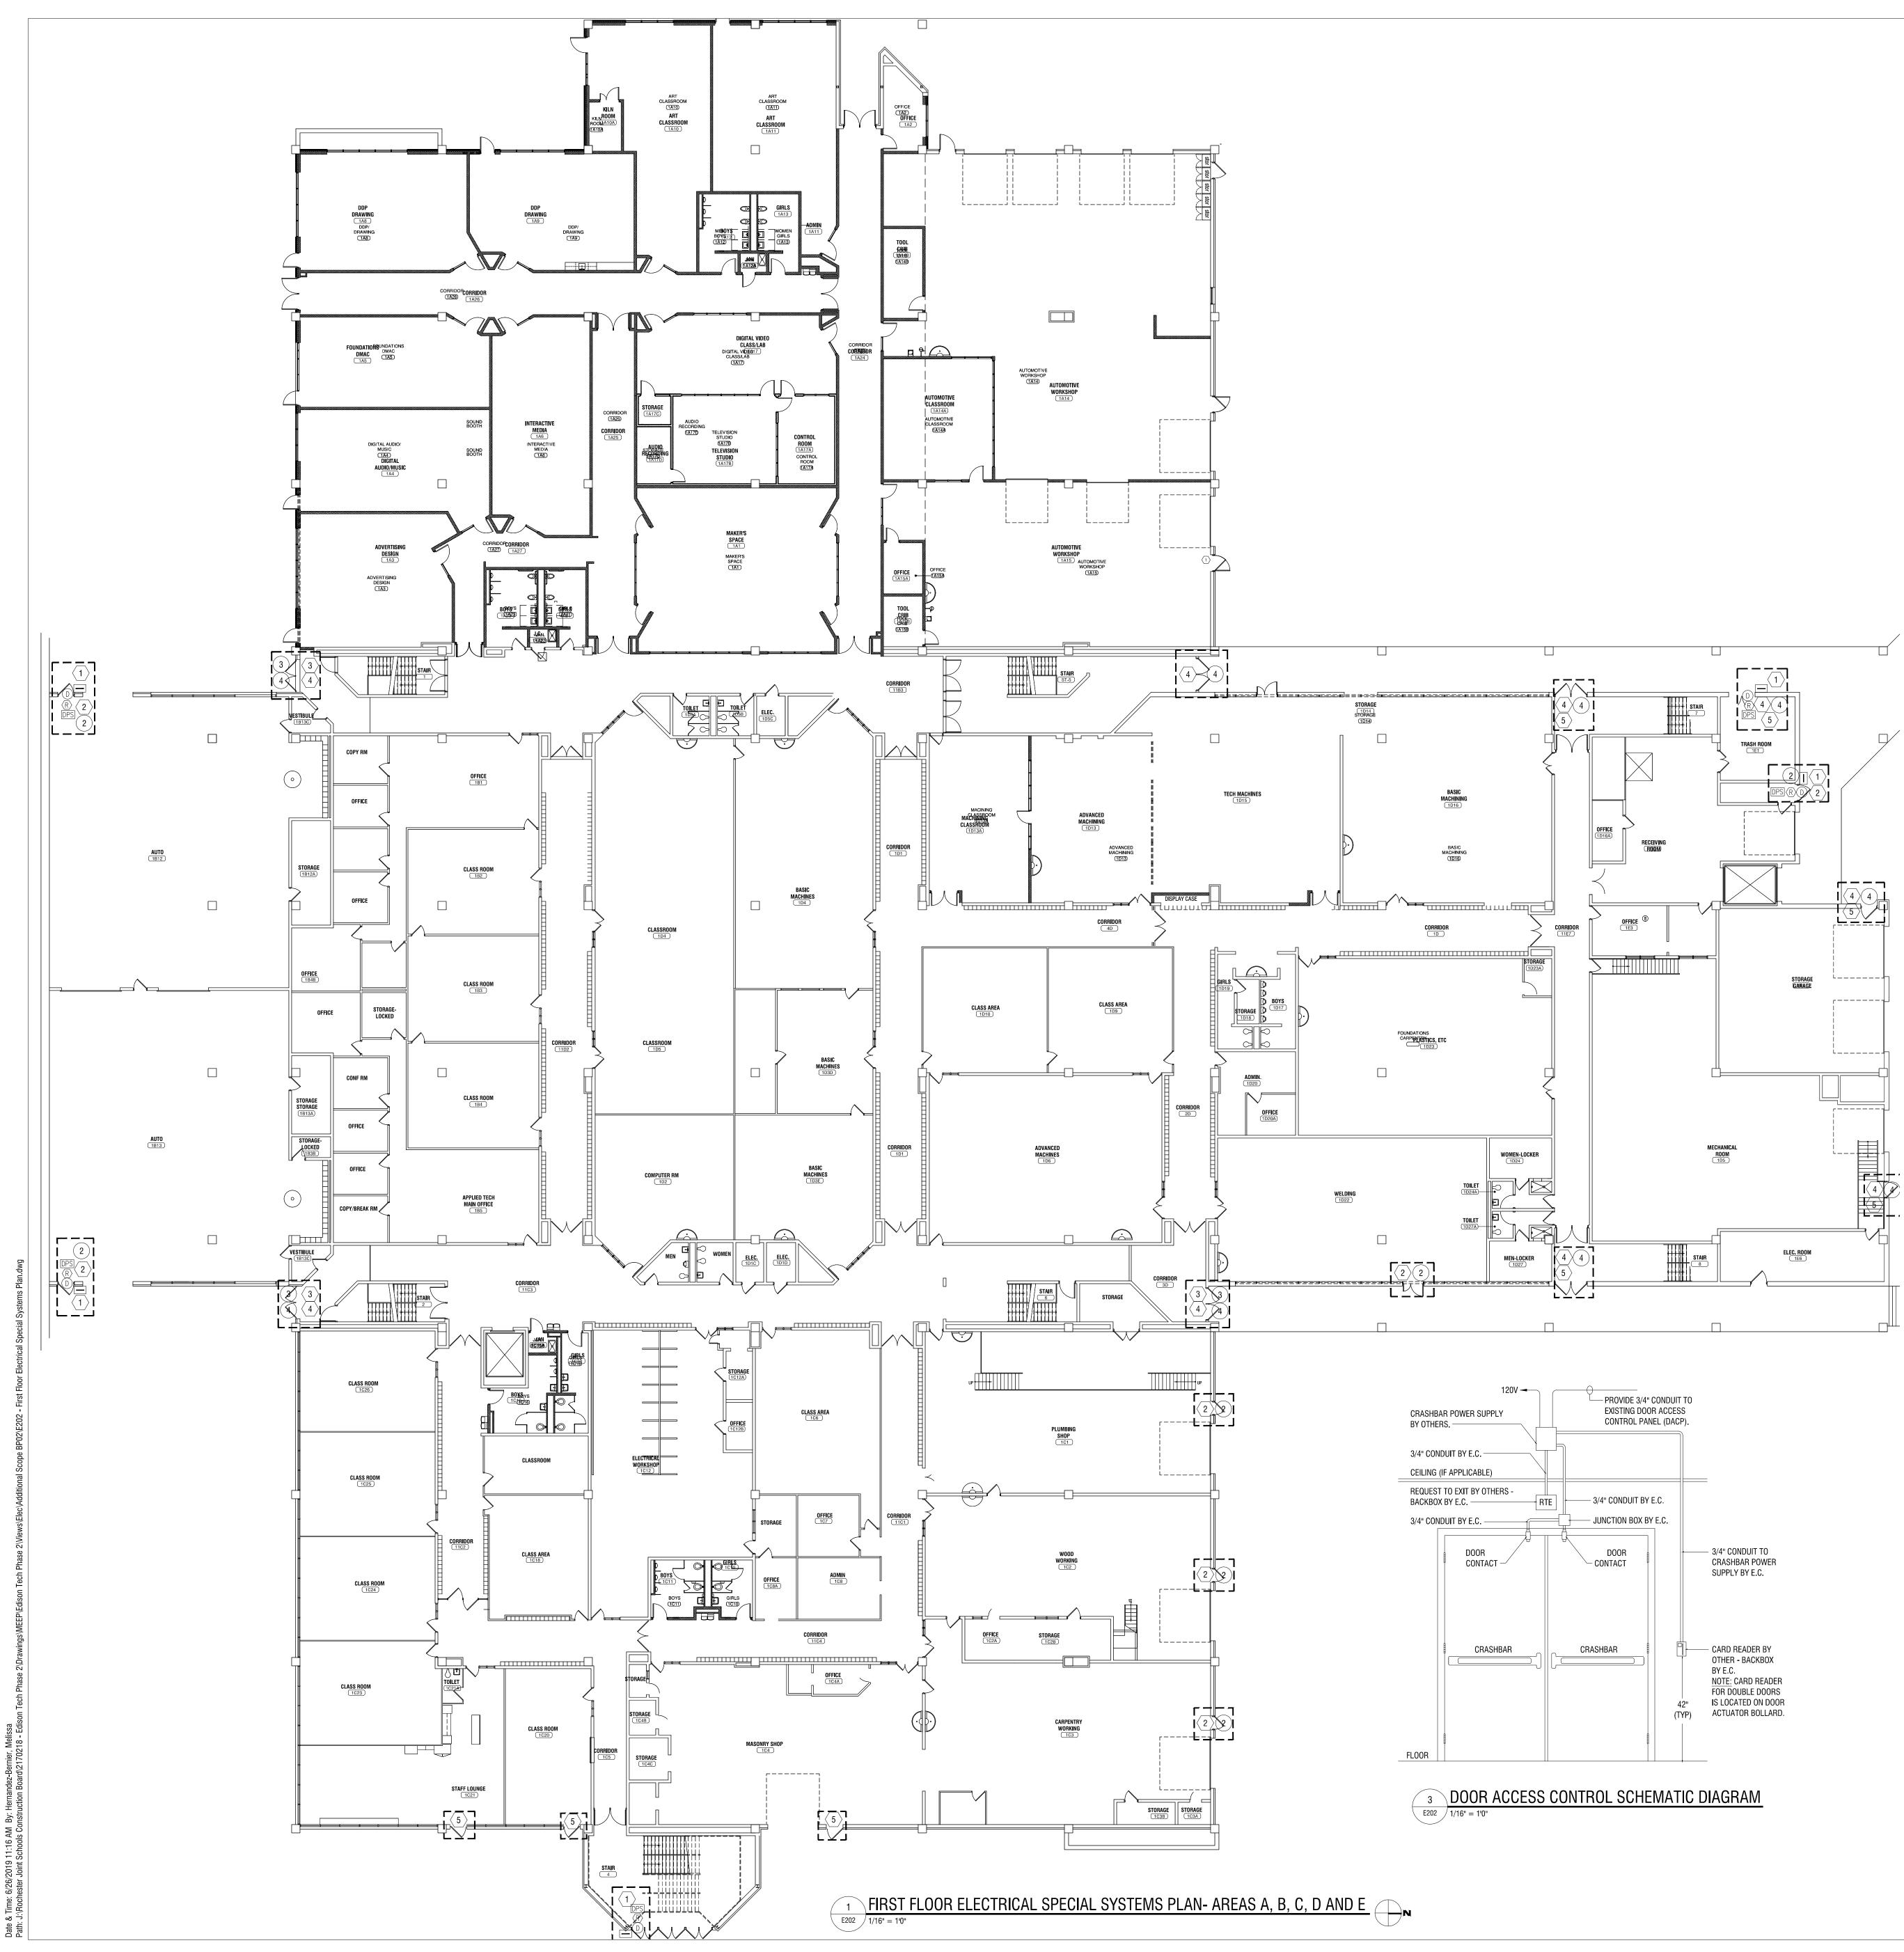


ELECTRIC DEMOLITION NOTES: 1) REMOVE EXISTING CARD READER.


- 2) REMOVE EXISTING EXIT SIGN AND POWER TO DEVICES THAT WILL
- INTERFERE WITH DOOR DEMOLITION AND NEW WORK. SAVE EXIT SIGNS AND WIRING FOR REUSE.
- (3) REMOVE EXIT SIGN. SAVE WIRING FOR REUSE.

(4) REMOVE POWER TO DEVICES THAT WILL INTERFERE WITH DOOR DEMOLITION AND NEW WORK.

ELECTRIC KEYED NOTES:


- 1 INSTALL NEW PROXIMITY CARD READER AND NECESSARY POWER FROM NEAREST PANEL WITH AVAILABLE SPARES. CARD READER TO MATCH BUILDING STANDARD.
- \langle 2 \rangle RE-INSTALL EXIT SIGN AND POWER REMOVED DURING DEMOLITION.
- \langle 3 angle provide New Ceiling mount exit sign. Reuse existing circuiting.
- $\langle 4 \rangle$ restore power connections impacted by demolition work.
- (5) PROVIDE NEW CEILING MOUNT EXIT SIGN. POWER SOURCE MUST BE

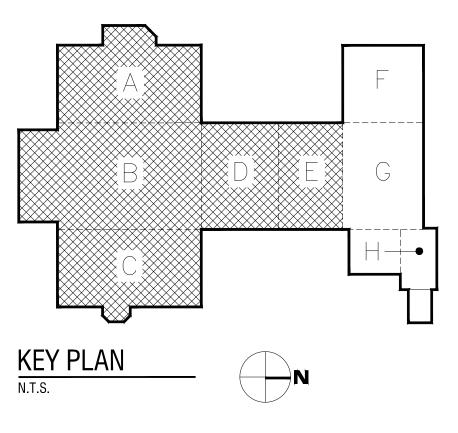

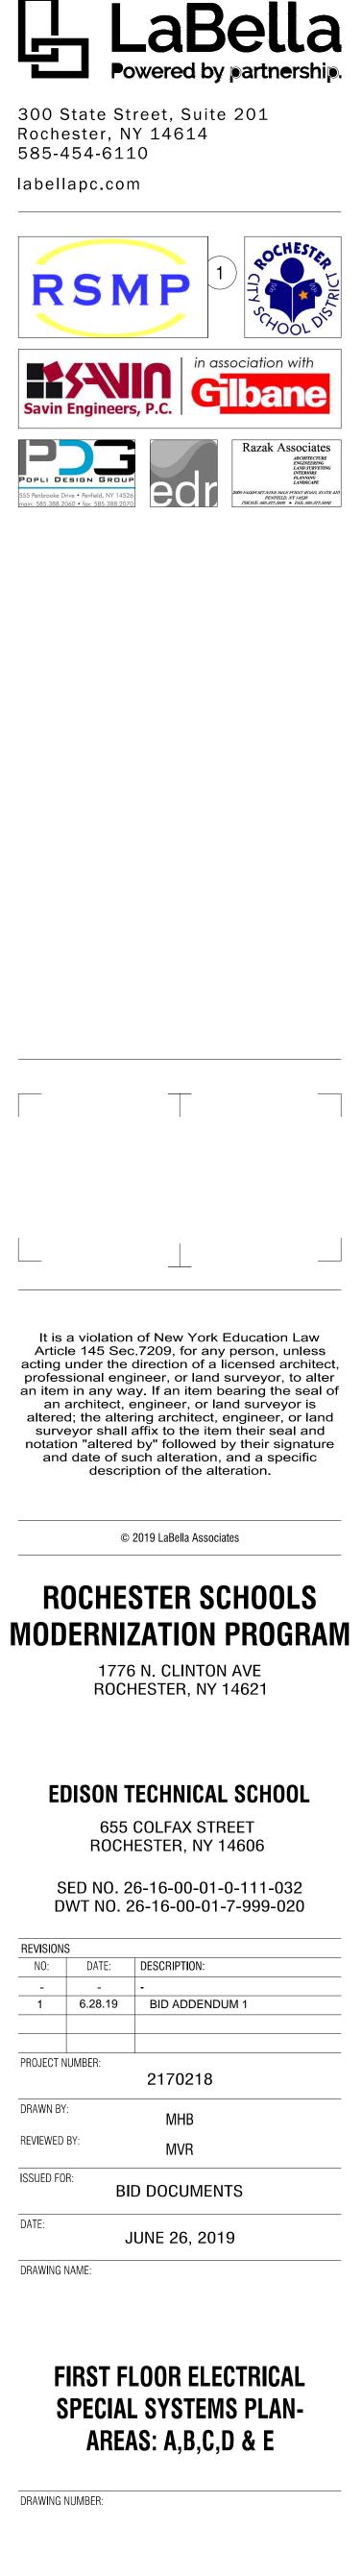






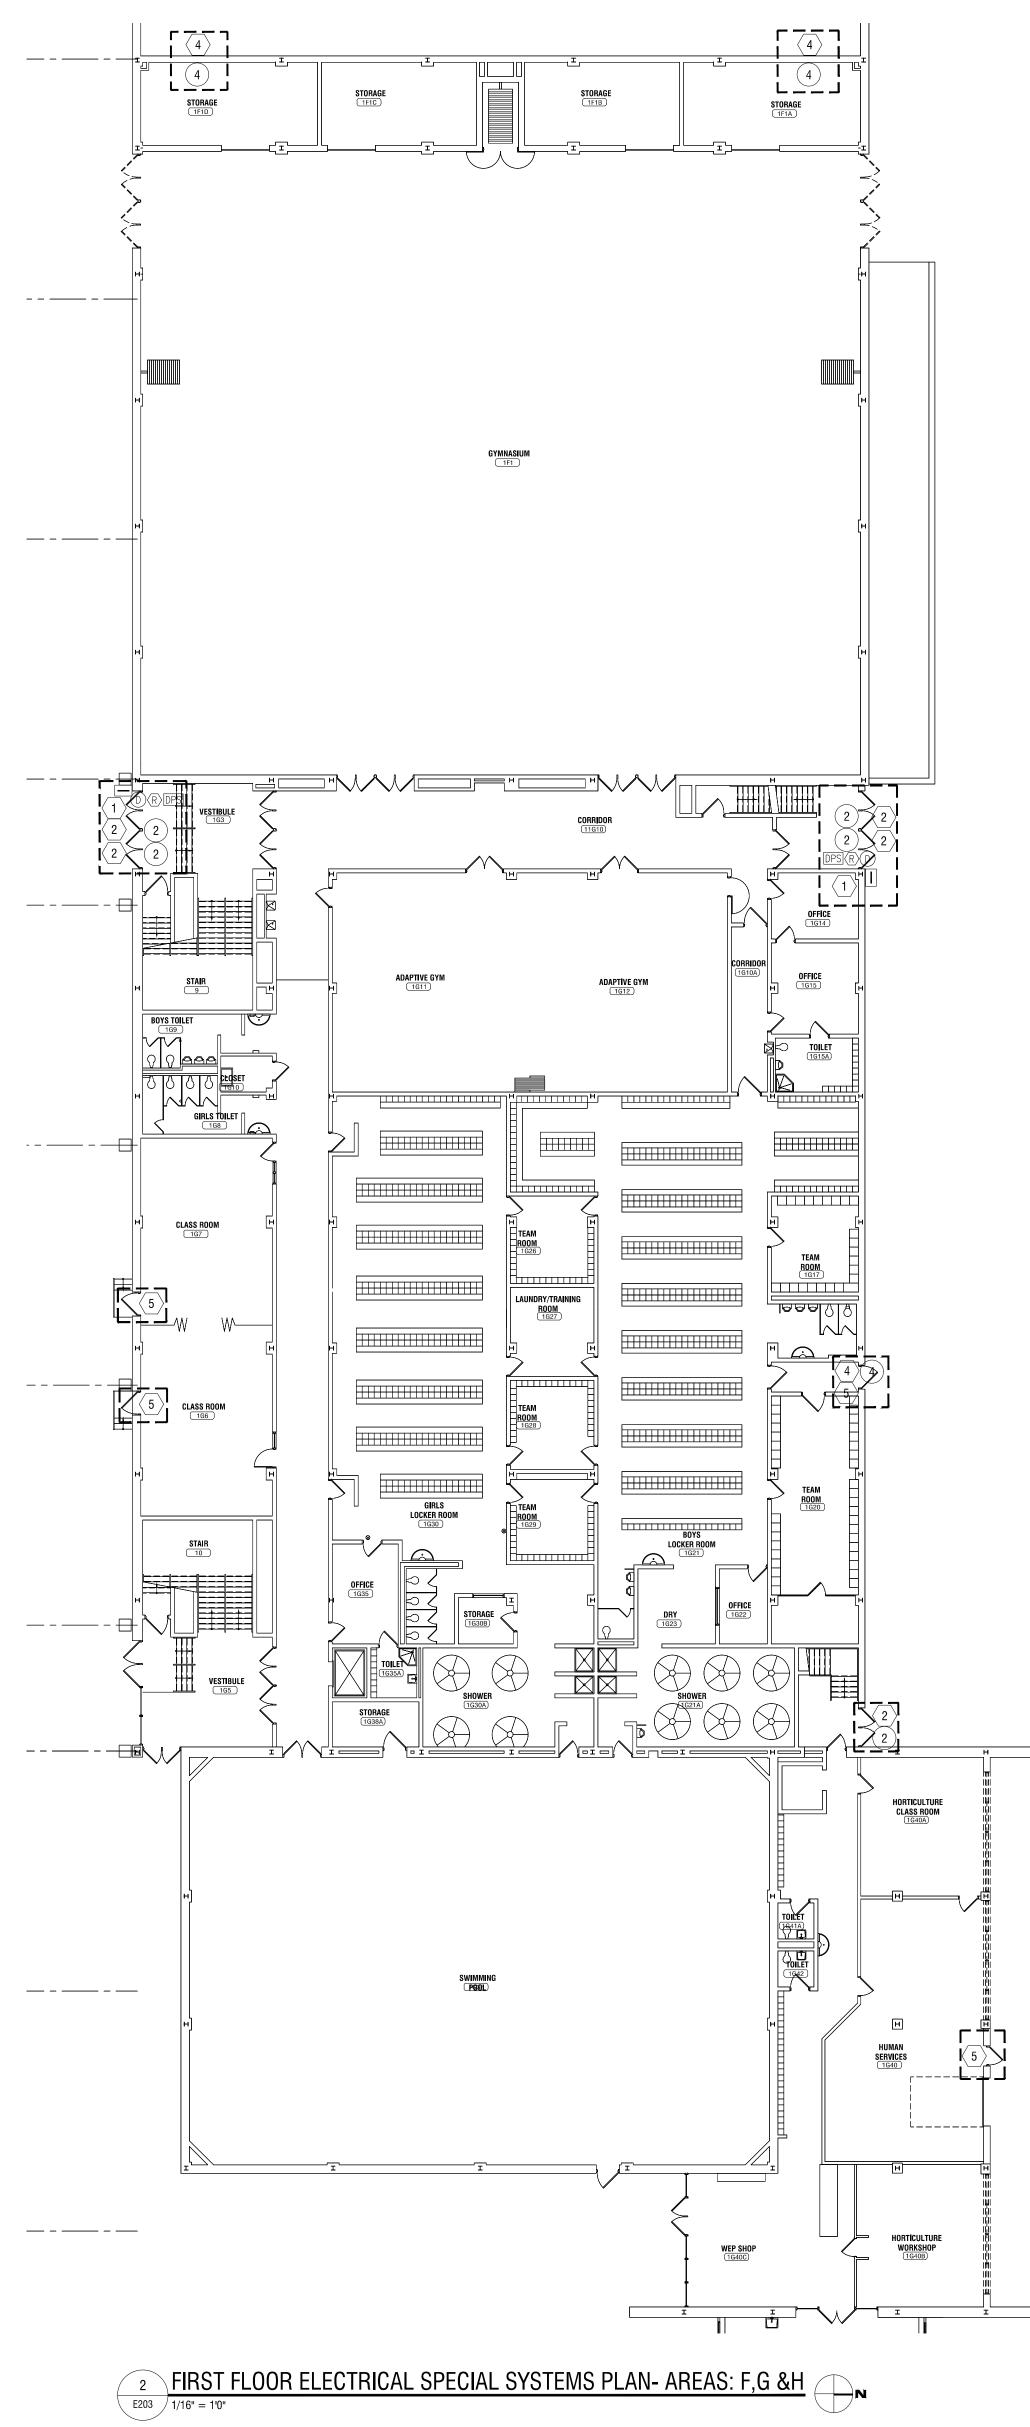


BY OTHERS. —


FLOOR

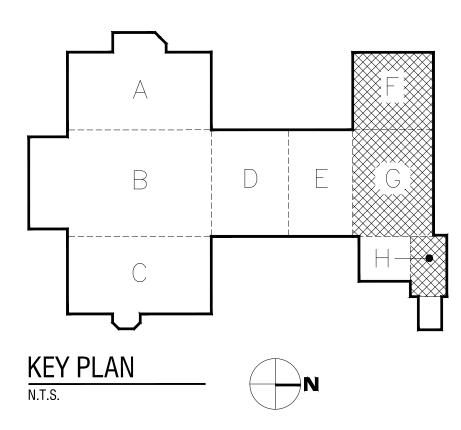


3 DOOR ACCESS CONTROL SCHEMATIC DIAGRAM

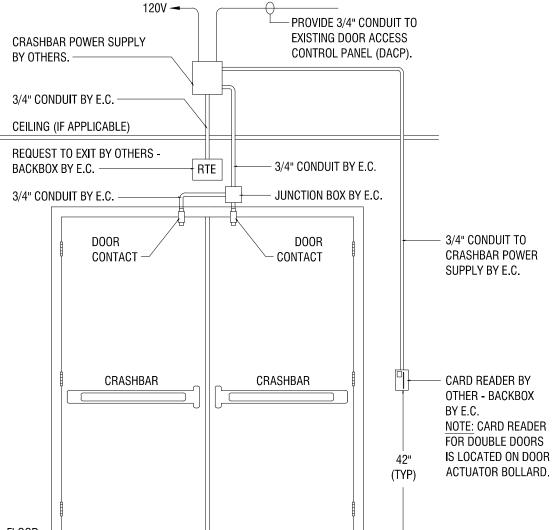

- $\langle 2 \rangle$ re-install exit sign and power removed during demolition. \langle 3 \rangle provide New Ceiling mount exit sign. Reuse existing circuiting. $\langle 4 \rangle$ RESTORE POWER CONNECTIONS IMPACTED BY DEMOLITION WORK. \langle 5 \rangle provide New Ceiling mount exit sign. Power source must be
- BUILDING STANDARD.
- ELECTRIC KEYED NOTES: 1 INSTALL NEW PROXIMITY CARD READER AND NECESSARY POWER FROM NEAREST PANEL WITH AVAILABLE SPARES. CARD READER TO MATCH
- (4) REMOVE POWER TO DEVICES THAT WILL INTERFERE WITH DOOR DEMOLITION AND NEW WORK.
- (3) REMOVE EXIT SIGN. SAVE WIRING FOR REUSE.
- (1) REMOVE EXISTING CARD READER. (2) REMOVE EXISTING EXIT SIGN AND POWER TO DEVICES THAT WILL INTERFERE WITH DOOR DEMOLITION AND NEW WORK. SAVE EXIT SIGNS AND WIRING FOR REUSE.
- ELECTRIC DEMOLITION NOTES:

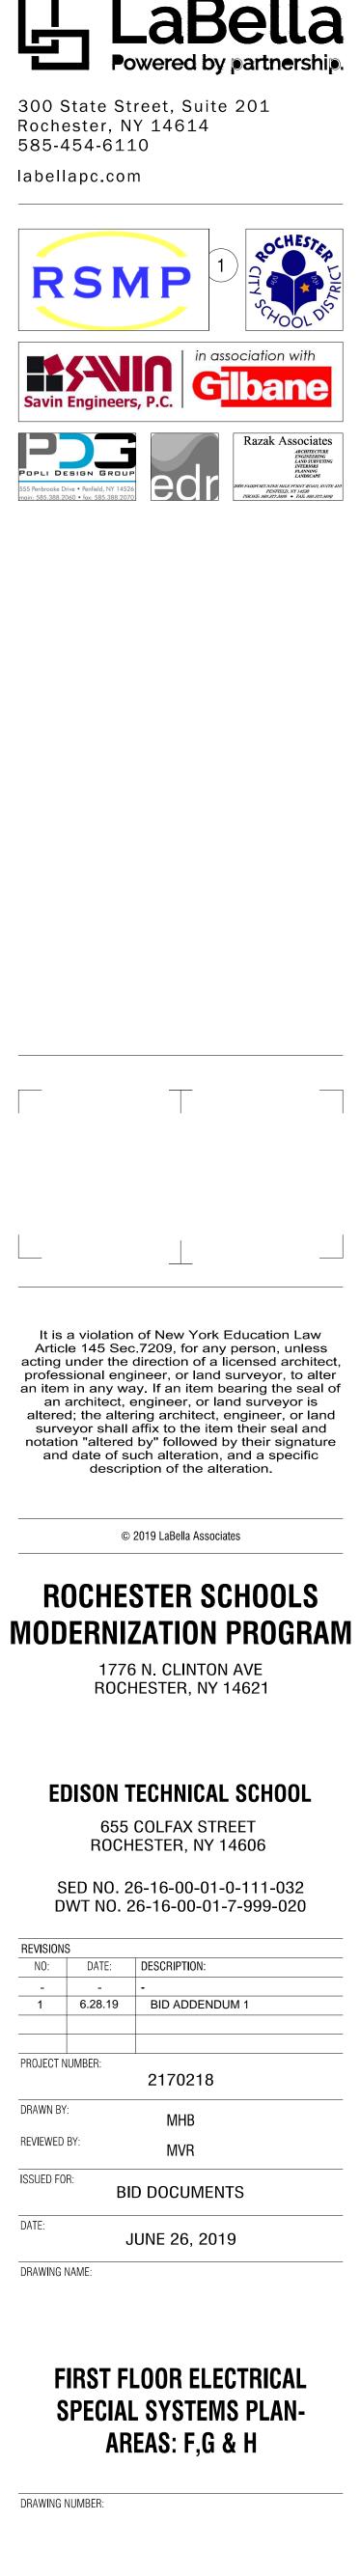

E203

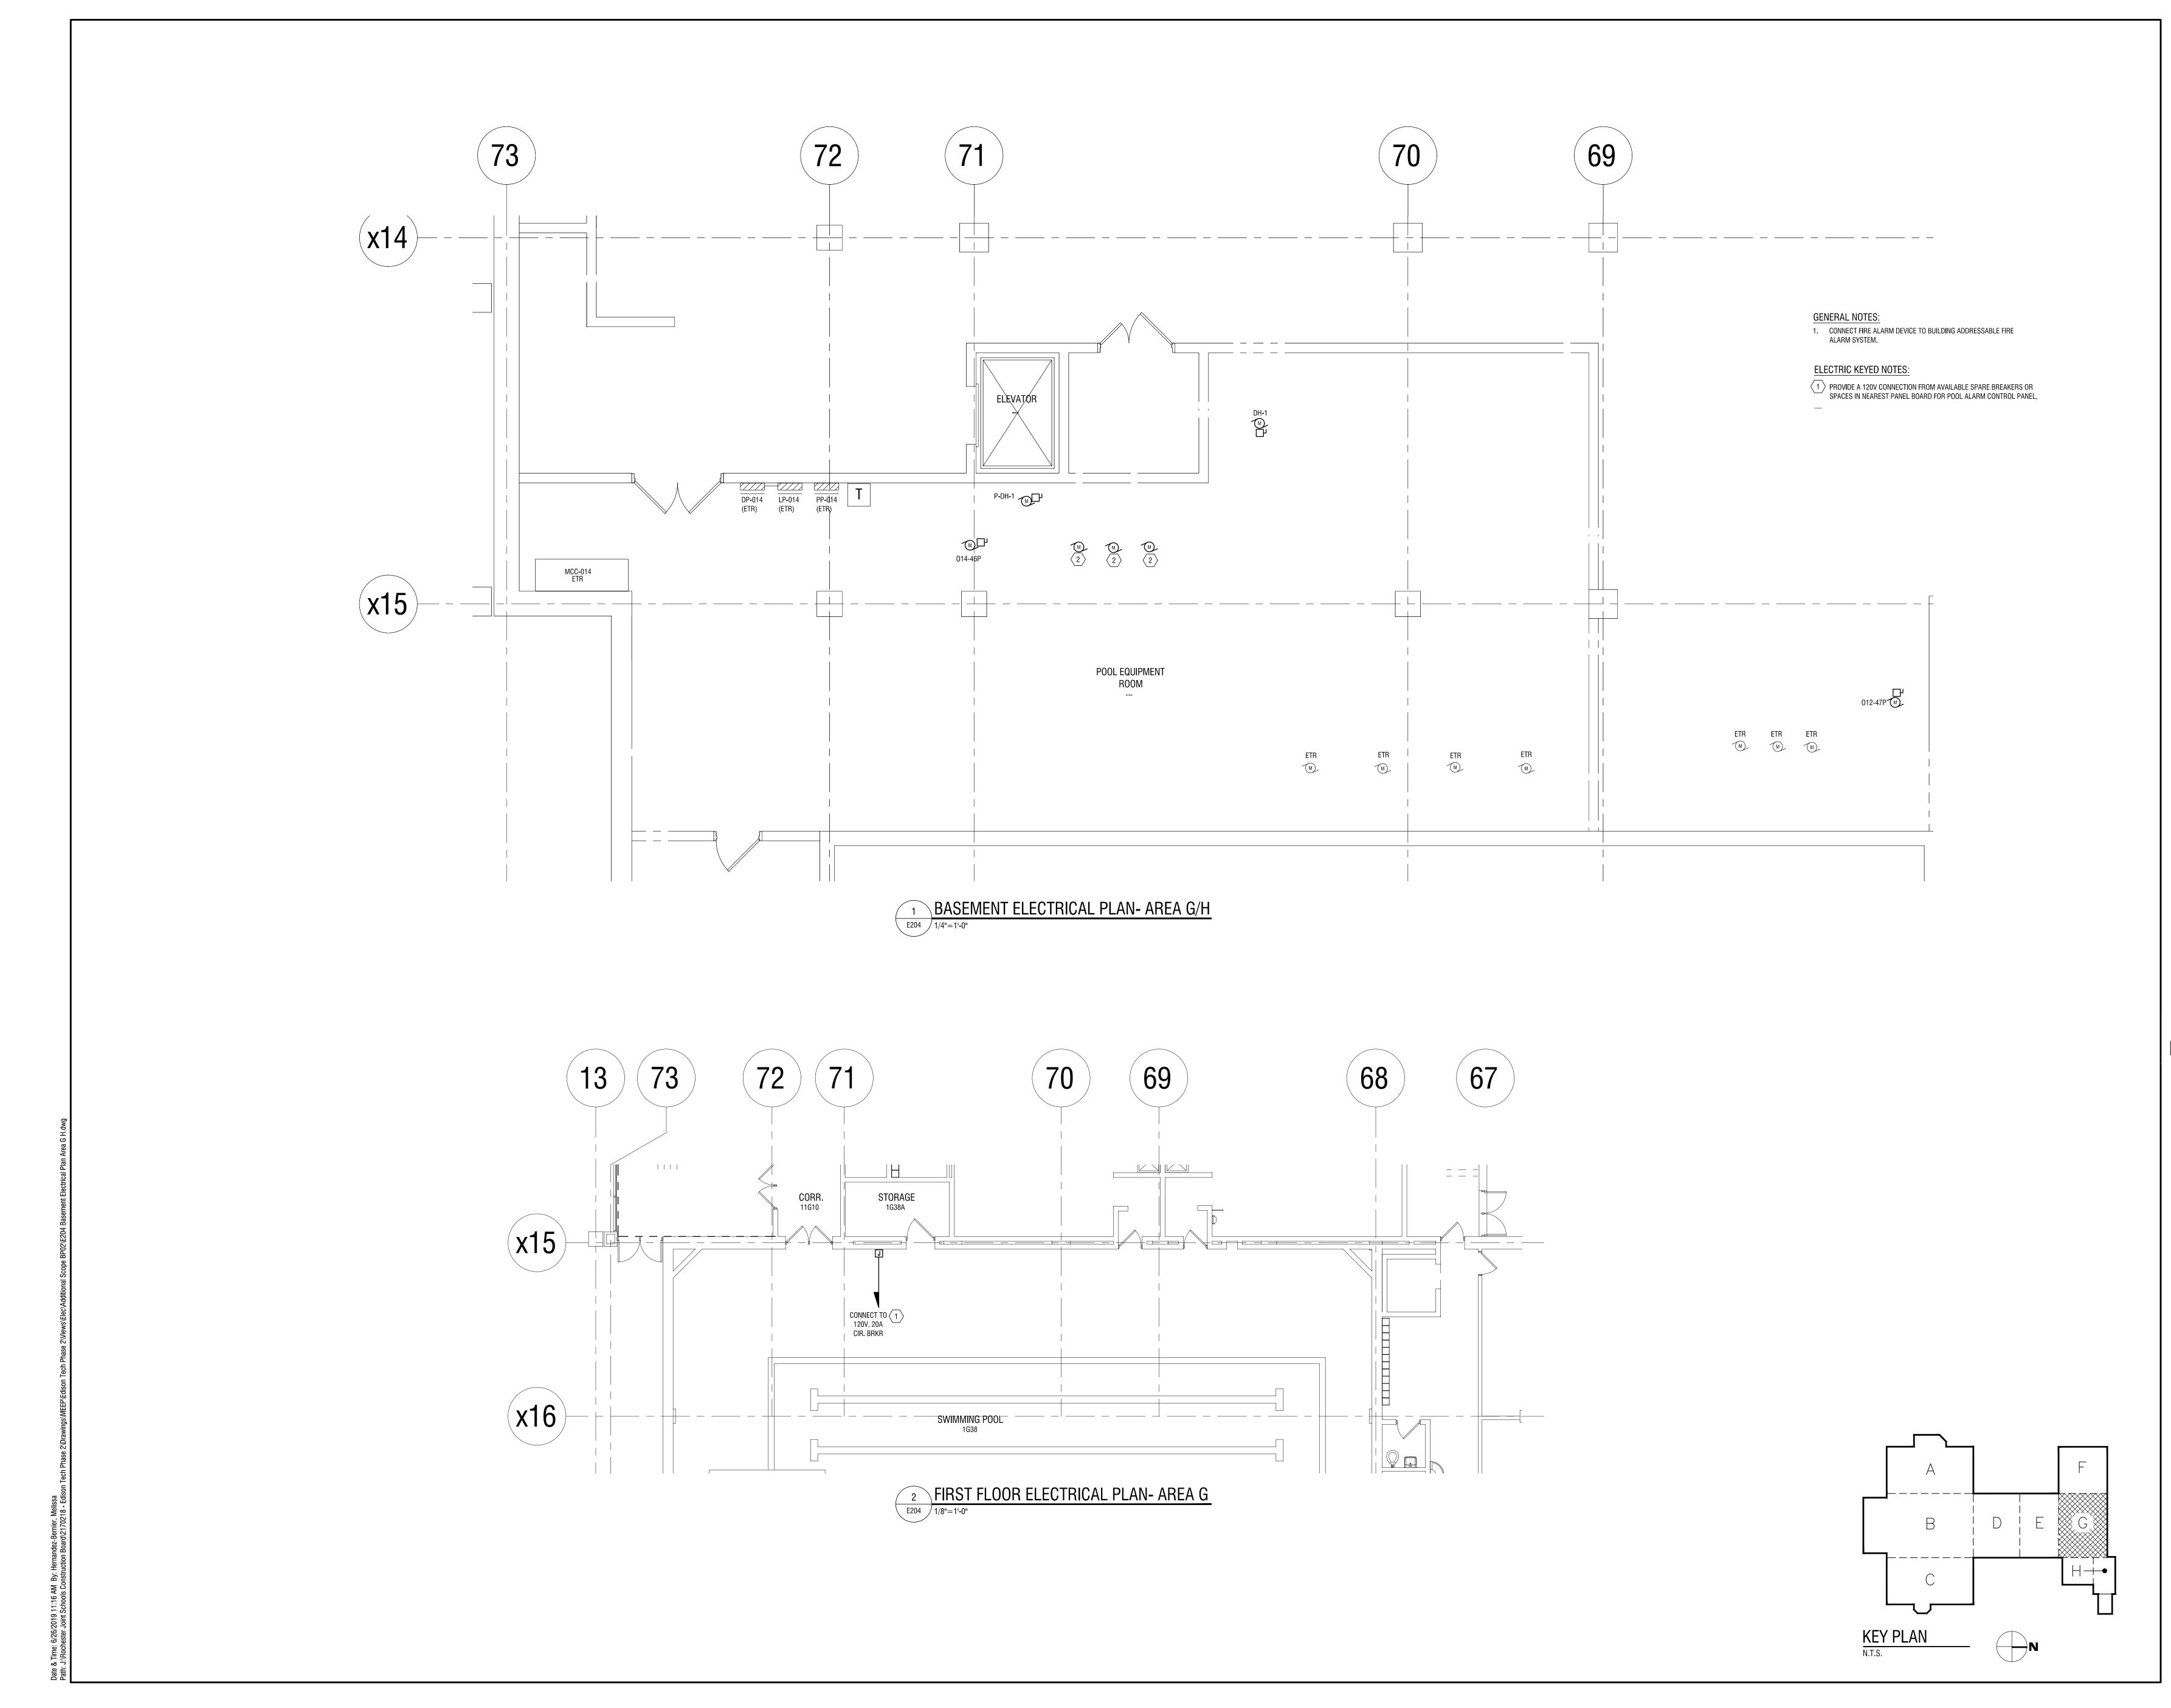



| Т | |
|--------|--|
| | |
| \bot | |

It is a violation of New York Education Law Article 145 Sec.7209, for any person, unless acting under the direction of a licensed architect, professional engineer, or land surveyor, to alter an item in any way. If an item bearing the seal of an architect, engineer, or land surveyor is altered; the altering architect, engineer, or land surveyor shall affix to the item their seal and notation "altered by" followed by their signature and date of such alteration, and a specific description of the alteration.

© 2019 LaBella Associates

ROCHESTER SCHOOLS MODERNIZATION PROGRAM 1776 N. CLINTON AVE ROCHESTER, NY 14621

EDISON TECHNICAL SCHOOL 655 COLFAX STREET ROCHESTER, NY 14606


SED NO. 26-16-00-01-0-111-032 DWT NO. 26-16-00-01-7-999-020


| REVISION | REVISIONS | | | | | |
|---------------|---------------|----------------|--|--|--|--|
| NO: | DATE: | DESCRIPTION: | | | | |
| _ | - | - | | | | |
| 1 | 6.28.19 | BID ADDENDUM 1 | | | | |
| | | | | | | |
| | | | | | | |
| PROJECT N | IUMBER: | | | | | |
| | 2170218 | | | | | |
| DRAWN BY: | | | | | | |
| МНВ | | | | | | |
| REVIEWED BY: | | | | | | |
| MVR | | | | | | |
| ISSUED FOR: | | | | | | |
| BID DOCUMENTS | | | | | | |
| DATE: | | | | | | |
| | JUNE 26, 2019 | | | | | |
| | | | | | | |

DRAWING NAME:

BASEMENT ELECTRICAL PLAN- AREA G/H



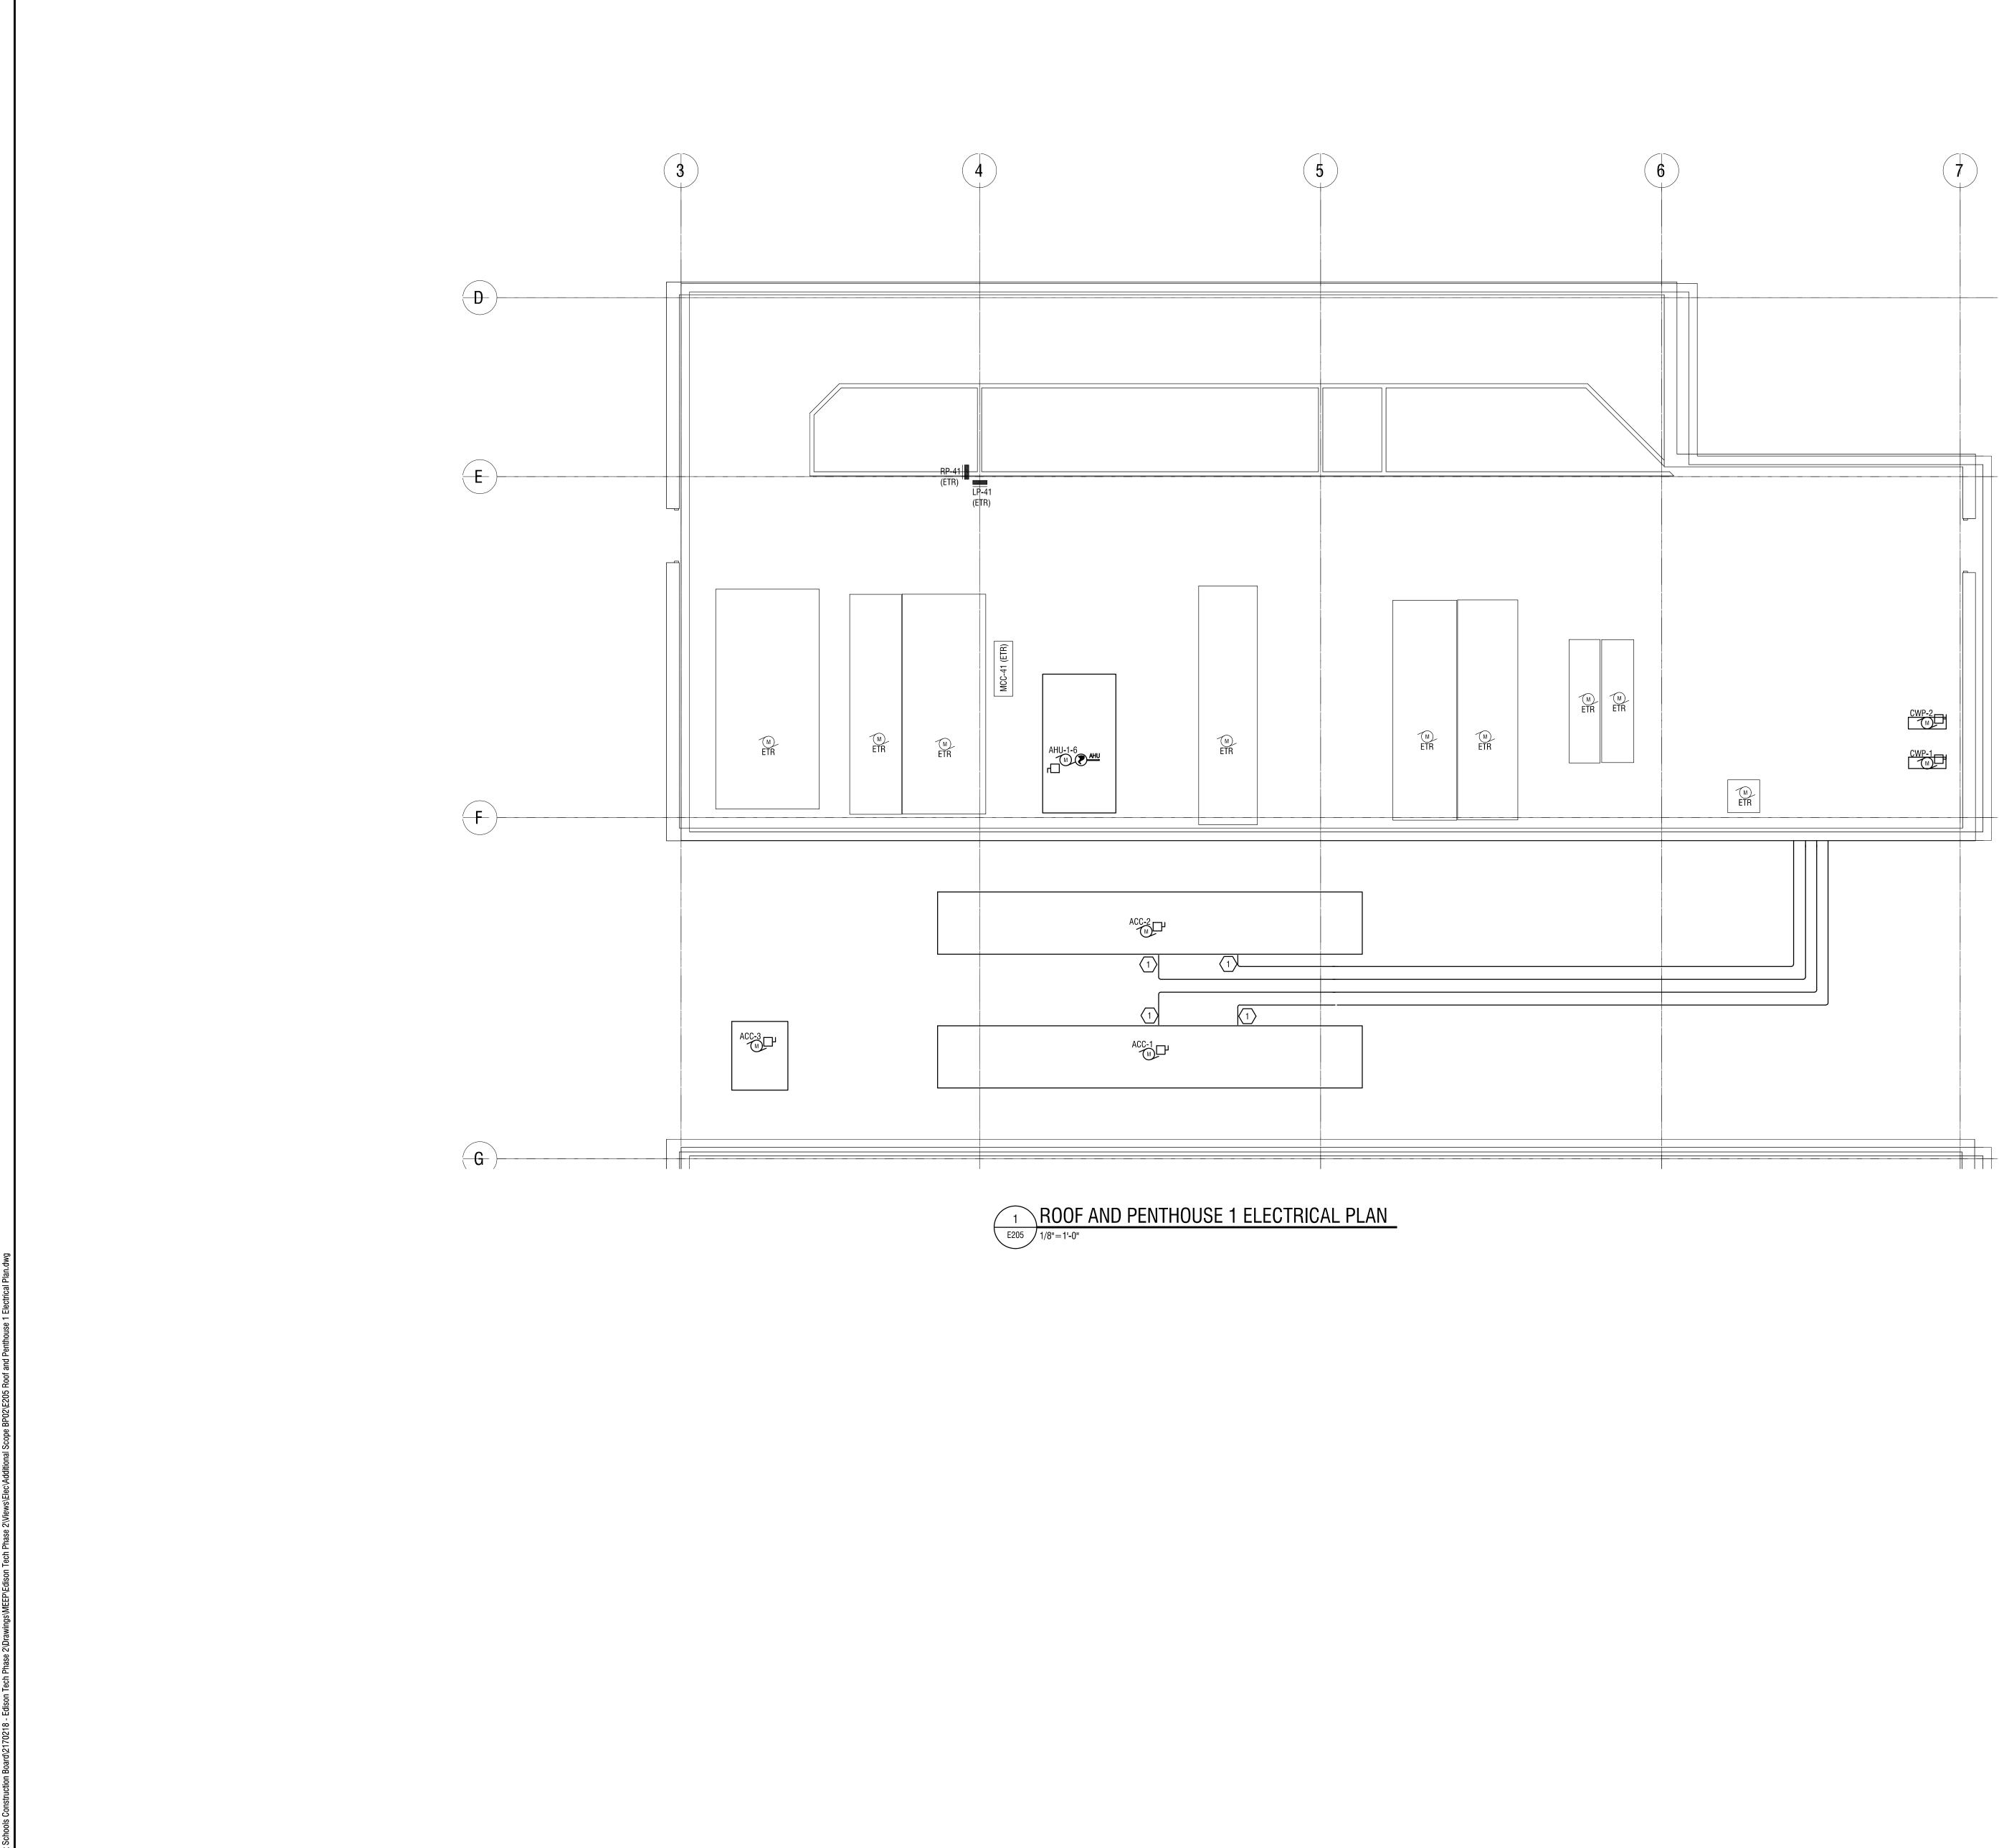


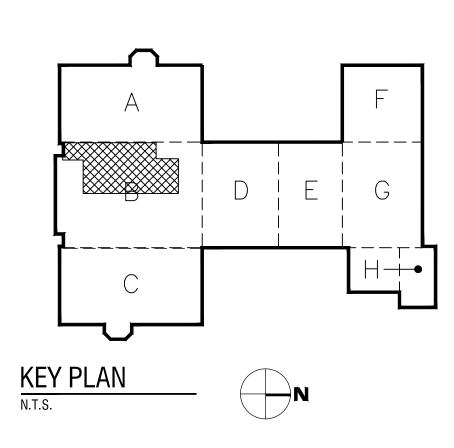

ELECTRIC KEYED NOTES:

GENERAL NOTES: 1. CONNECT FIRE ALARM DEVICE TO BUILDING ADDRESSABLE FIRE ALARM SYSTEM.

1 PROVIDE POWER FOR PIPING HEAT TRACING FROM PANELS LP-41 OR RP-41. DESIGN BASIS APPROXIMATE POWER CONSUMPTION IS 8 WATTS/LF.

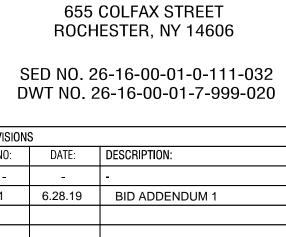

It is a violation of New York Education Law

Article 145 Sec.7209, for any person, unless acting under the direction of a licensed architect,

acting under the direction of a licensed architect, professional engineer, or land surveyor, to alter an item in any way. If an item bearing the seal of an architect, engineer, or land surveyor is altered; the altering architect, engineer, or land surveyor shall affix to the item their seal and notation "altered by" followed by their signature and date of such alteration, and a specific description of the alteration.

description of the alteration.

© 2019 LaBella Associates

ROCHESTER SCHOOLS

MODERNIZATION PROGRAM

1776 N. CLINTON AVE

ROCHESTER, NY 14621

EDISON TECHNICAL SCHOOL

LaBella Powered by partnership.

Savin Engineers, P.C.

Razak Associates BERGER BROUP S55 Penbrooke Drive • Penfield, NY 14526 main: 585.388.2000 • fax: 585.388.2007

300 State Street, Suite 201 Rochester, NY 14614 585-454-6110

labellapc.com

RSMP


| REVISION | S | | |
|-----------------|-----------|----------------|--|
| NO: | DATE: | DESCRIPTION: | |
| _ | - | - | |
| 1 | 6.28.19 | BID ADDENDUM 1 | |
| | | | |
| | | | |
| PROJECT NUMBER: | | | |
| | | 2170218 | |
| DRAWN BY | | | |
| | | MHB | |
| Reviewed by: | | MVR | |
| | | | |
| ISSUED FO | R: BII | D DOCUMENTS | |
| | DI | DOODMENTO | |
| DATE: | | | |
| | | LINE 26 2019 | |


JUNE 20, 2019

DRAWING NAME:

ROOF AND PENTHOUSE 1 Electrical plan




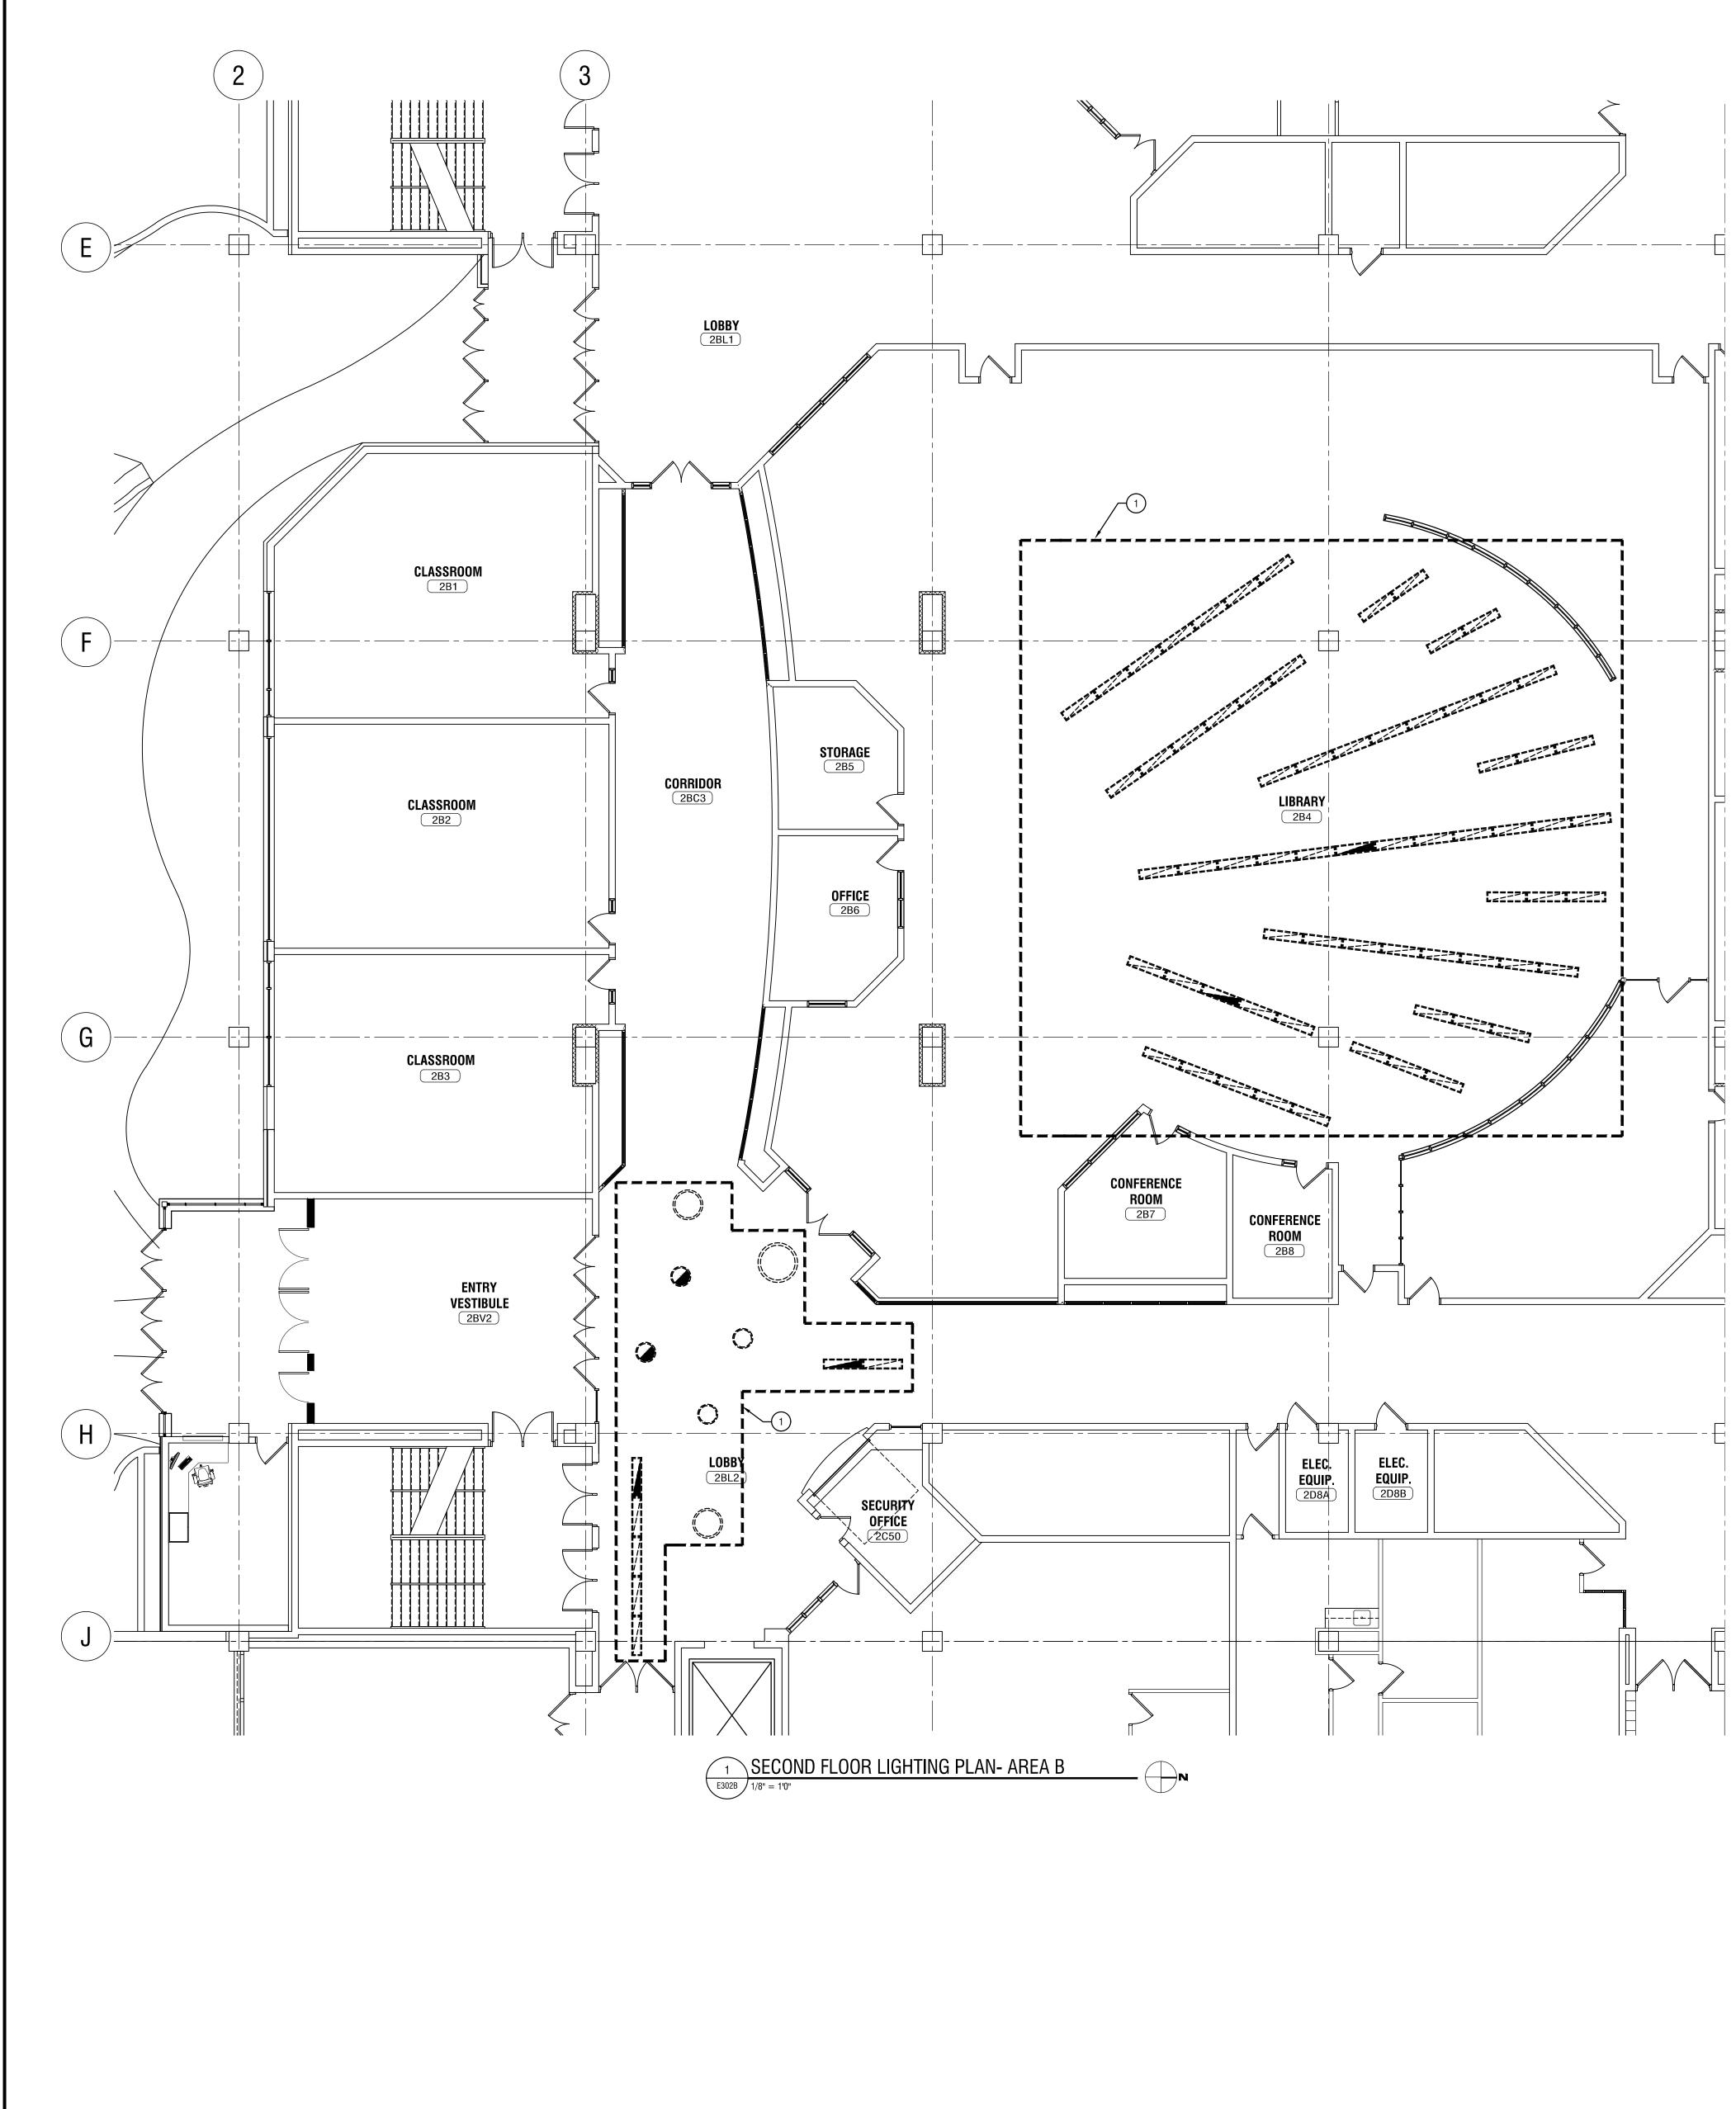

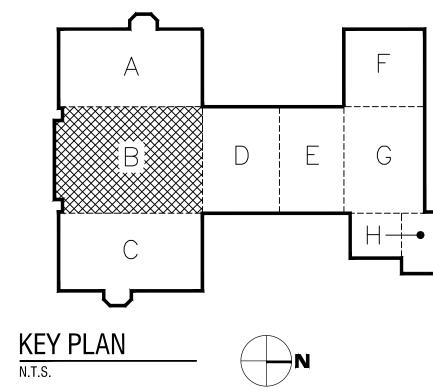



ELECTRIC DEMOLITION KEY NOTES:

1 DISCONNECT AND REMOVE AREA LIGHTING THAT WILL INTERFERE WITH NEW CEILING WORK. REINSTALL LUMINAIRES PROVIDING NEW SUPPORTS AS NECESSARY.

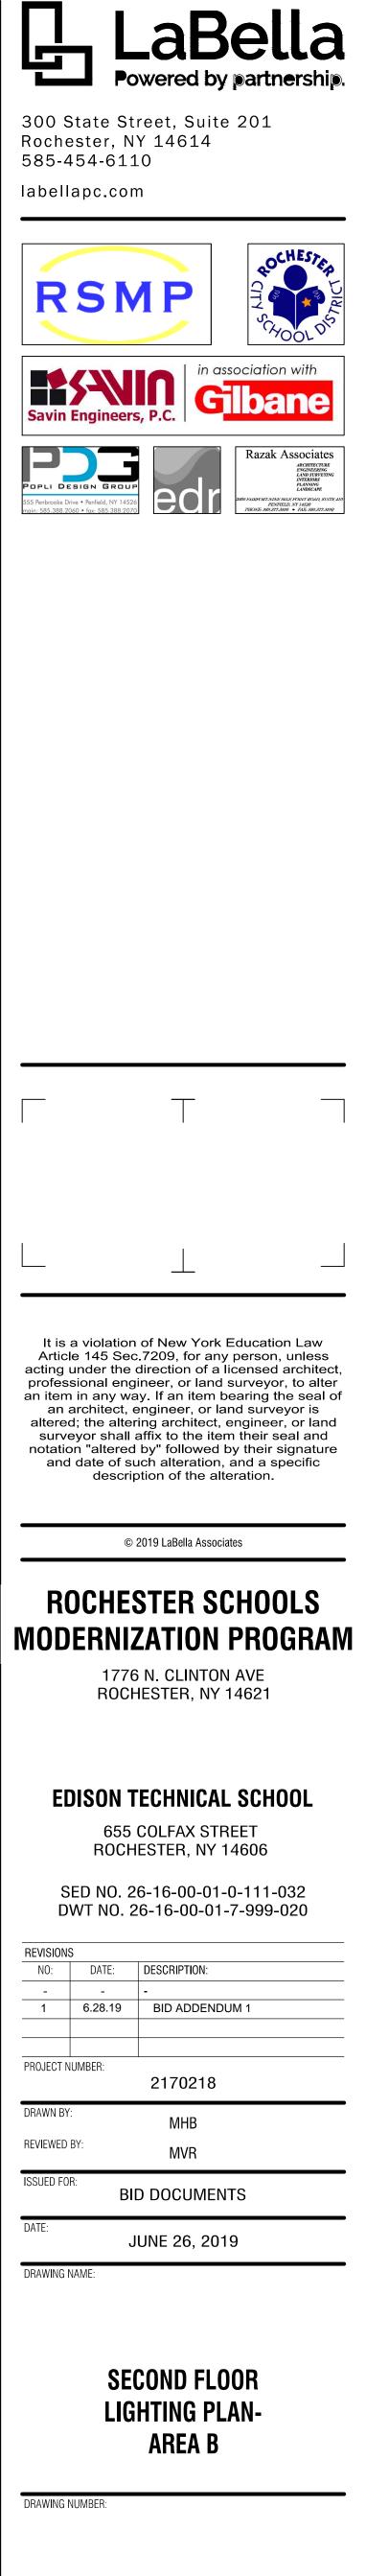



E302B

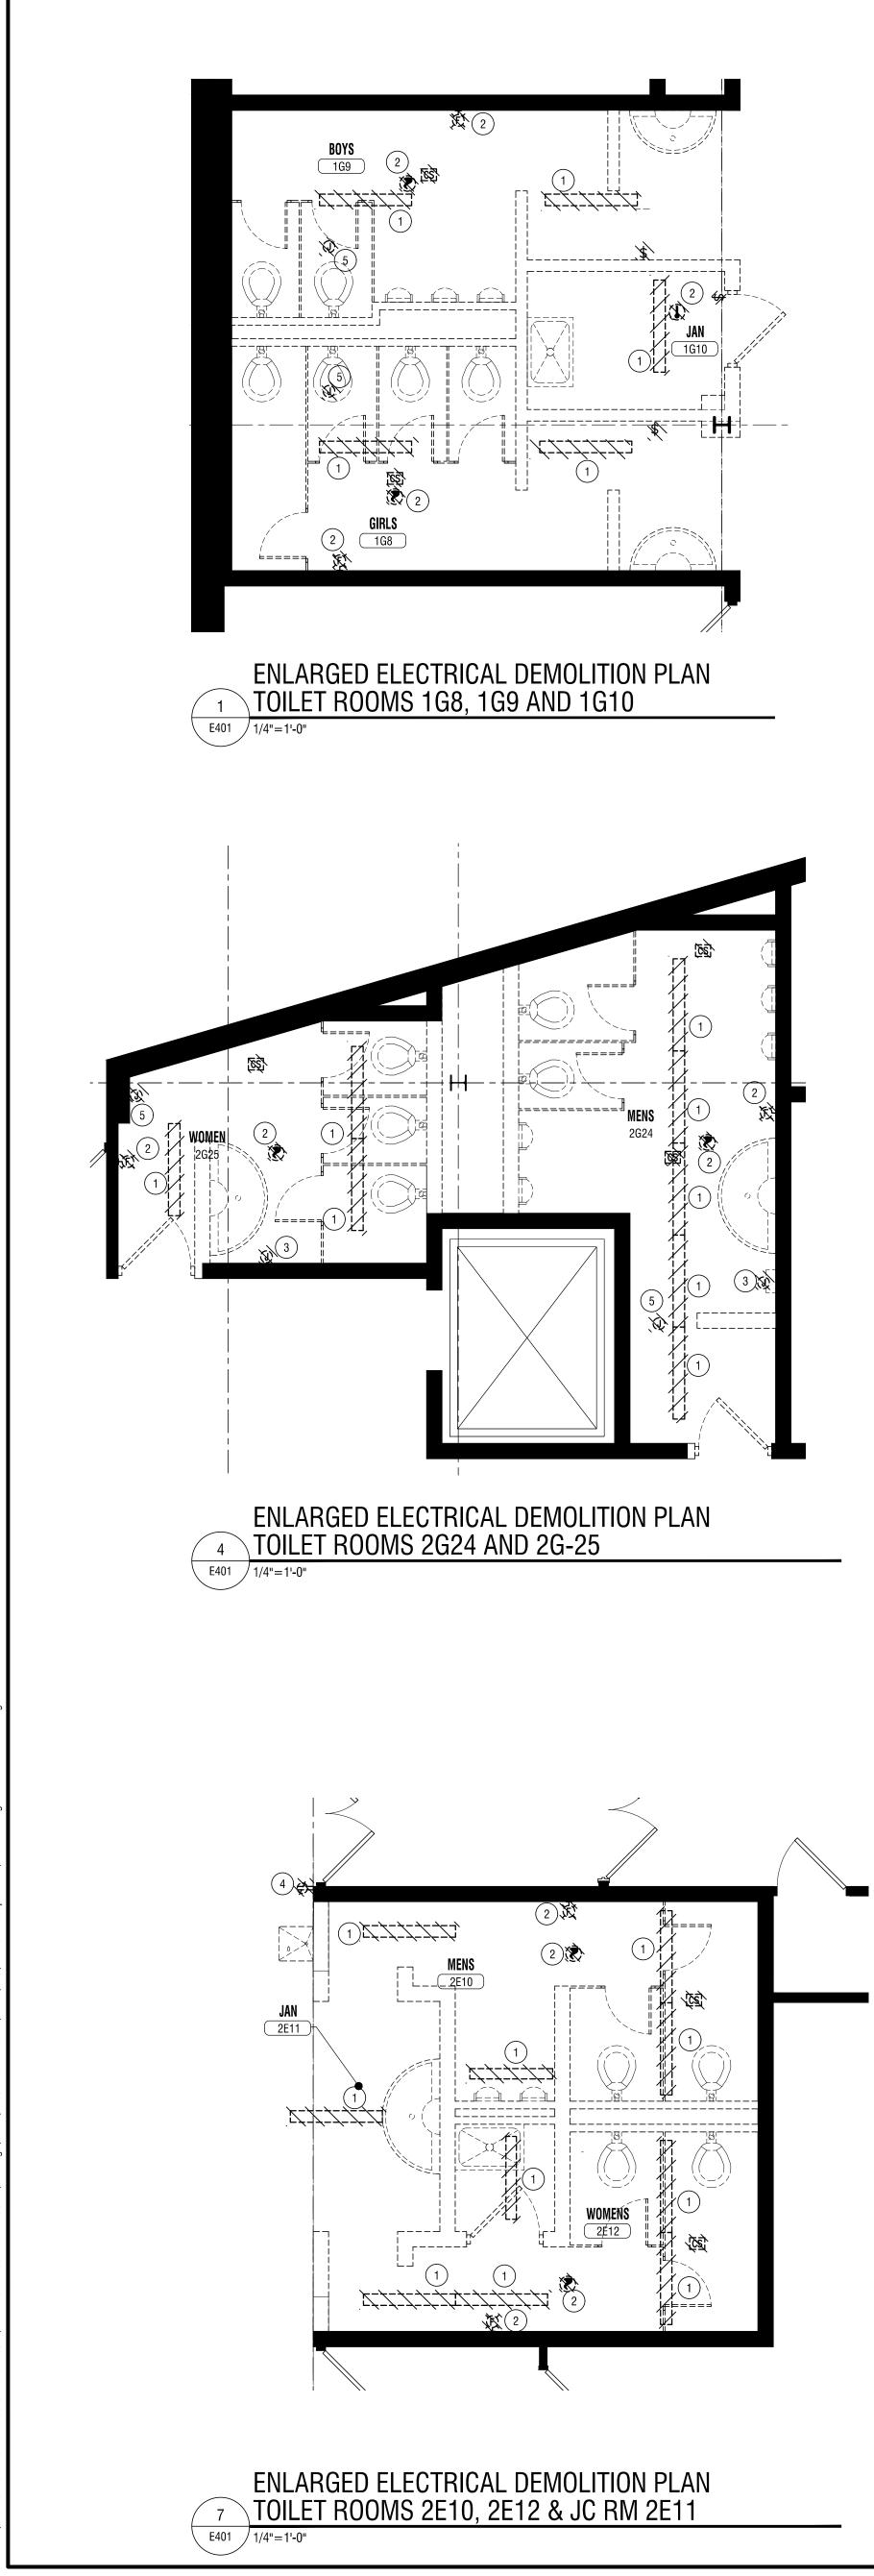

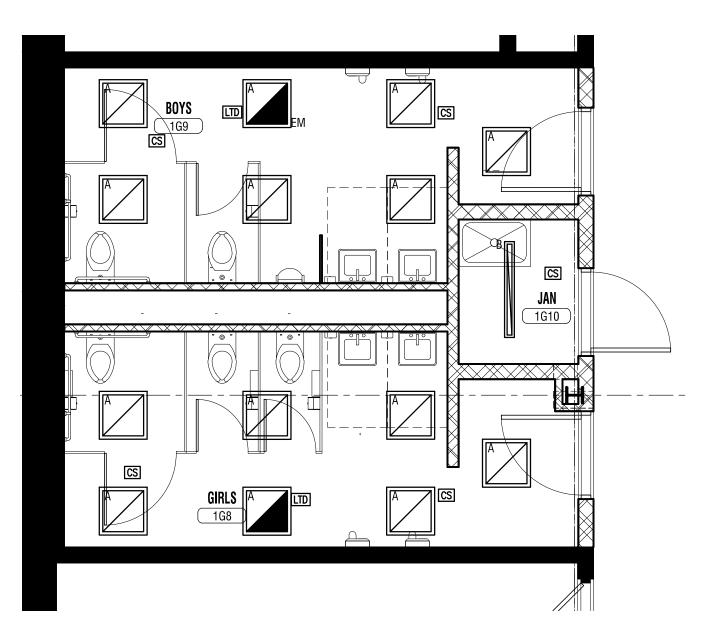


ENLARGED LIGHTING PLAN ² TOILET ROOMS 1G8, 1G9 AND 1G10 E401 / 1/4"=1'-0"

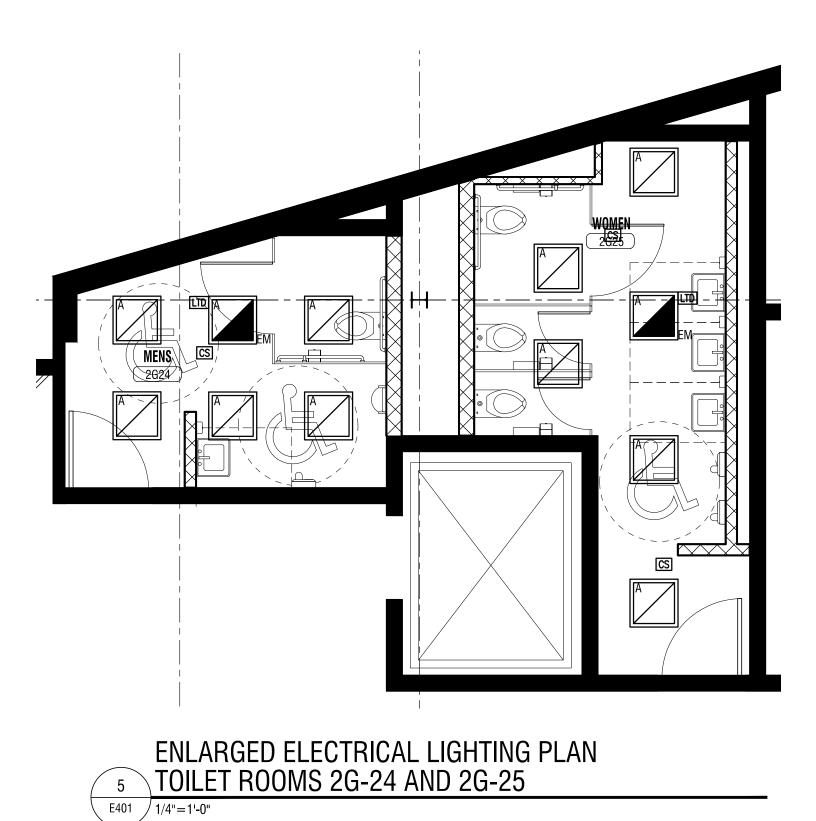


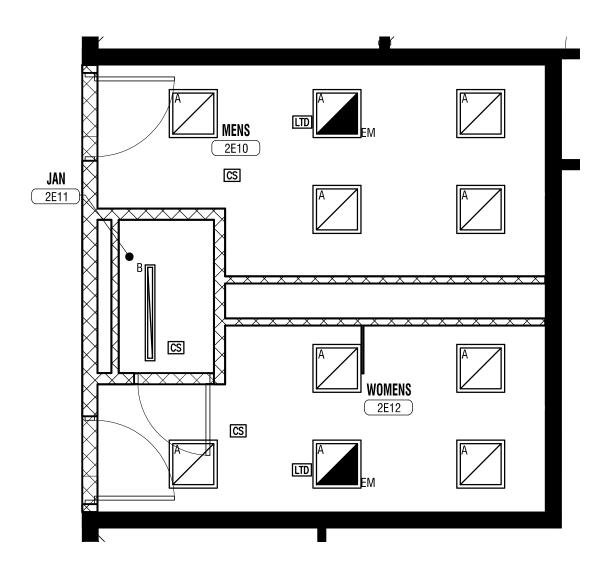


ENLARGED ELECTRICAL LIGHTING PLAN TOILET ROOMS 2E10, 2E12 & JC RM 2E11 E401 1/4"=1'-0"

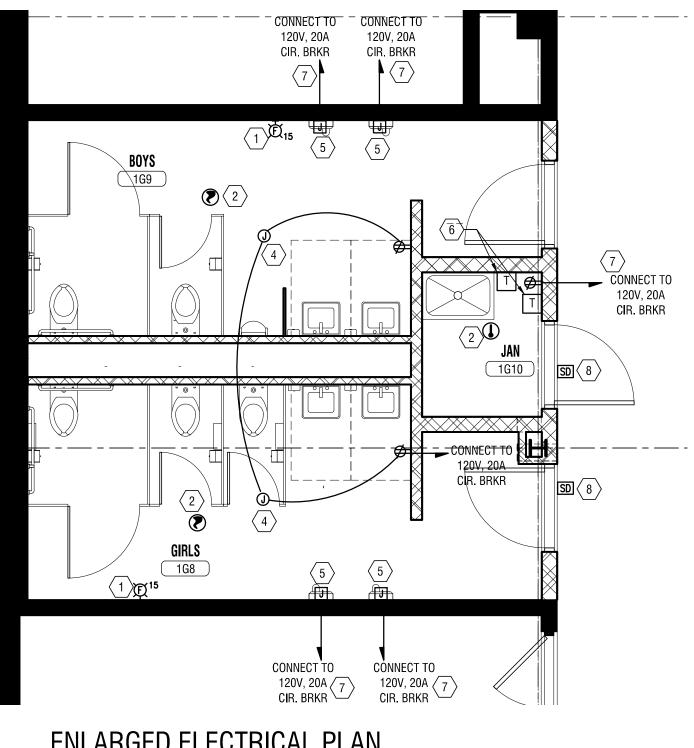



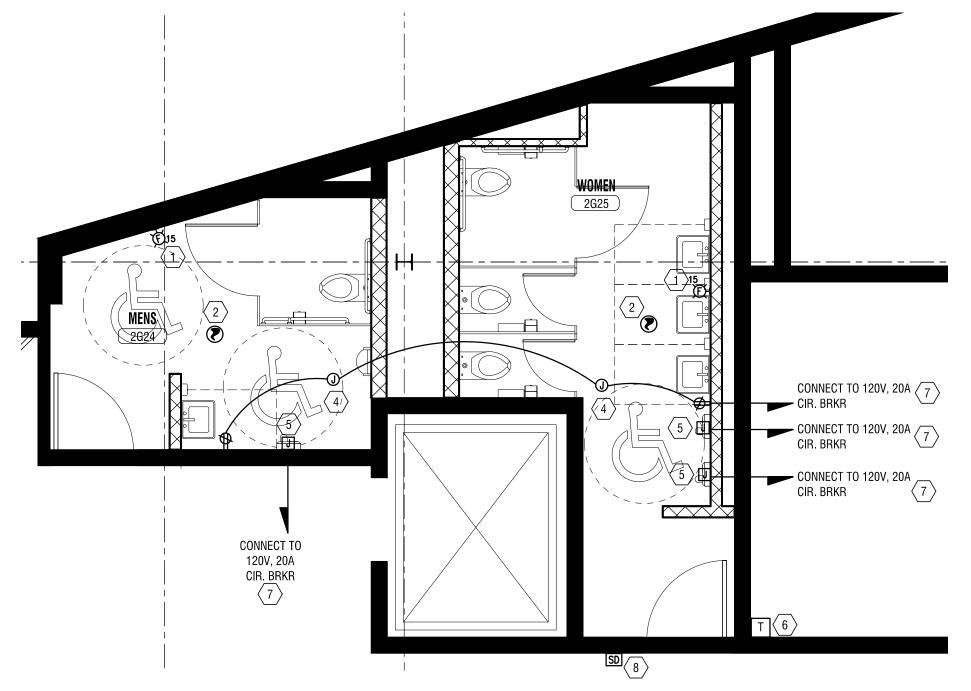




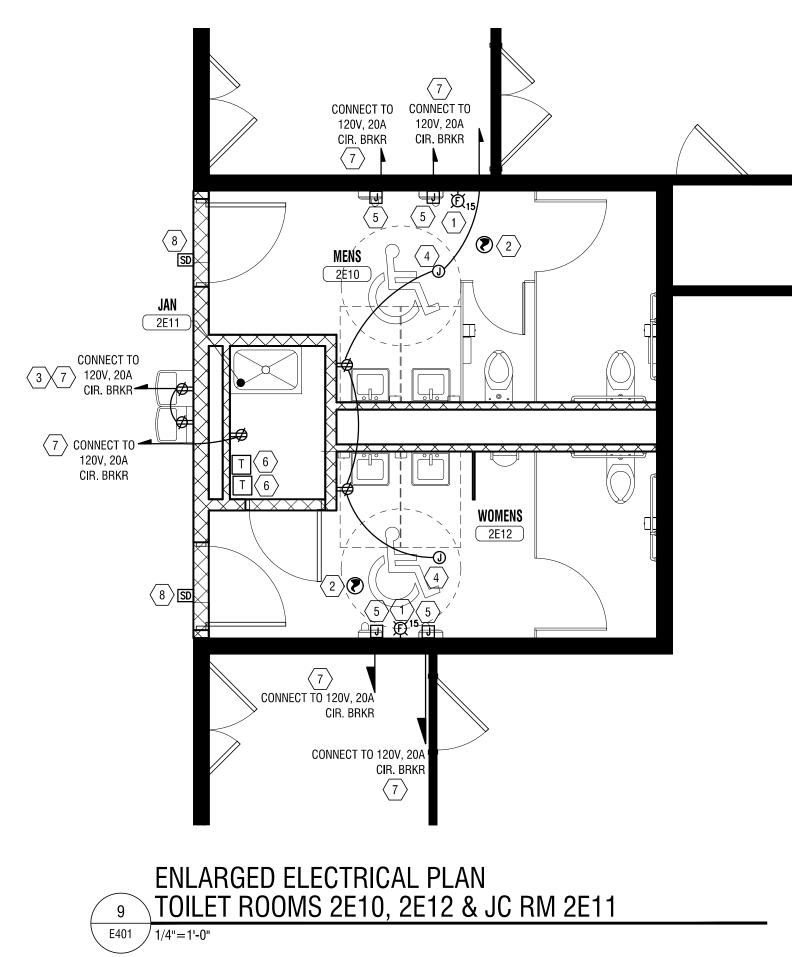

ENLARGED ELECTRICAL PLAN <u>6</u> TOILET ROOMS 2G-24 AND 2G-25

- **ELECTRIC DEMOLITION NOTES:**
- (1) DISCONNECT AND REMOVE EXISTING LIGHT FIXTURES AND ASSOCIATED LIGHTING CONTROLS. REUSE EXISTING CIRCUITING.
- 2 REMOVE EXISTING FIRE ALARM DEVICES AND SAVE FOR REUSE. REUSE EXISTING COVERS AND WIREGUARDS WHERE POSSIBLE. COIL WIRING ABOVE THE CEILING FOR REUSE.
- 3 REMOVE ELECTRICAL CONNECTION TO EXISTING HAND DRYER. SAVE CIRCUIT FOR REUSE.
- (4) REMOVE EXISTING RECEPTACLE .
- (5) DISCONNECT POWER FROM EXISTING EXHAUST FAN. SAVE EXISTING WIRING AND CONDUITS FOR REUSE FOR THE NEW EXHAUST FAN INSTALLATION.
- ELECTRIC KEYED NOTES:
- $\langle 1
 angle$ re-install addressable light strobe. Extend wiring as
- NECESSARY.
- $\langle 2 \rangle$ RE-INSTALL ADDRESSABLE HEAT/SMOKE DETECTOR, WITH WIRE GUARD.
- 3 PROVIDE GFCI RECEPTACLE FOR DRINKING FOUNTAIN, COORDINATE EXACT LOCATION AND ELEVATION WITH PLUMBING CONTRACTOR.
- \langle 4 \rangle provide junction box above ceiling for water closet/urinal and AUTO FLUSH VALVE TRANSFORMER. CIRCUIT AS INDICATED. COORDINATE EXACT LOCATION WITH PLUMBING CONTRACTOR.
- 5 PROVIDE POWER FOR HAND DRYER. CIRCUIT AS INDICATED. COORDINATE EXACT LOCATION WITH GENERAL CONTRACTOR.
- (6) PROVIDE CONTROL TRANSFORMER FOR FIRE DAMPER, PRIMARY 120/277VAC, SECONDARY 24VAC, 40VA MAXIMUM. MOUNT TRANSFORMER NEAR FIRE DUMPER. CONNECT TO NEAREST 120V OR 277V, 20A EMERGENCY LIGHTING CIRCUIT. PROVIDE POWER TO ACTUATOR CONTROLLER THRU A FIRE SYSTEM RELAY- MOUNT RELAY ADJACENT TO DAMPER. PROGRAM RELAY TO CLOSE DAMPER WHEN ANY SPACE SMOKE DETECTOR GOES INTO ALARM. COORDINATE WIRING AND INSTALLATION WITH MECHANICAL CONTRACTOR.
- $\langle 7 \rangle$ CIRCUIT TO AVAILABLE SPACE IN NEAREST POWER PANEL 120/208V. PROVIDE 20A-1P CIRCUIT BREAKER AS REQUIRED. PROVIDE (2)#12 AND (1)#12 GRN IN 1/2" EMT. COORDINATE IN FIELD.
- $\langle 8 \rangle$ POWER TO SMOKE DAMPER ACTUATORS MUST BE THROUGH A FIRE SYSTEM RELAY. RELAY TO BE MOUNTED ADJACENT TO DAMPER, UPON NEAREST CORRIDOR SMOKE DETECTOR ACTIVATION. RELAY SENDS ACTUATOR SIGNAL TO CLOSE DAMPER. REFER TO MECHANICAL PLANS FOR FIRE SMOKE DAMPER LOCATION,

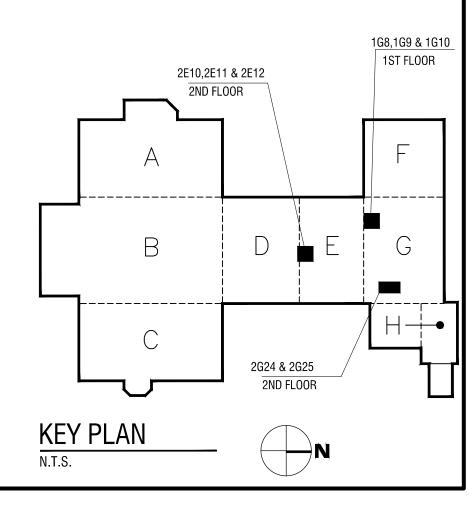



DRAWING NUMBER:

ENLARGED **ELECTRICAL PLANS** 1 ST & 2 ND FLR

DRAWING NAME:

| REVISION | S | | | |
|-----------------|---------|----------------|--|--|
| NO: | DATE: | DESCRIPTION: | | |
| _ | - | - | | |
| 1 | 6.28.19 | BID ADDENDUM 1 | | |
| | | | | |
| | | | | |
| PROJECT NUMBER: | | | | |
| | | 2170218 | | |
| DRAWN BY: MHB | | | | |
| REVIEWED | RY | | | |
| MVR | | MVR | | |
| ISSUED FOR: | | | | |
| | BII | D DOCUMENTS | | |
| | | | | |
| DATE: | | UNE 26, 2019 | | |

SED NO. 26-16-00-01-0-111-032 DWT NO. 26-16-00-01-7-999-020

655 COLFAX STREET ROCHESTER, NY 14606

EDISON TECHNICAL SCHOOL

1776 N. CLINTON AVE ROCHESTER, NY 14621

ROCHESTER SCHOOLS MODERNIZATION PROGRAM

© 2019 LaBella Associates

an architect, engineer, or land surveyor is altered; the altering architect, engineer, or land surveyor shall affix to the item their seal and notation "altered by" followed by their signature and date of such alteration, and a specific description of the alteration.

It is a violation of New York Education Law Article 145 Sec.7209, for any person, unless acting under the direction of a licensed architect, professional engineer, or land surveyor, to alter an item in any way. If an item bearing the seal of

RSM **In association with Gibane** in association with Razak Associates ARCHITECTU ENGINEERIN LAND SURVE INTERIORS PLANNING LANDSCAPE ear 2060 FAIRPORT-NINE MILE FOINT ROAD, SUITE 410 PENFIELD, NY 14526 PHONE: 585-377.3550 + FAX: 585-377.3559

